NOTE: BUILDER TO VERIFY LOCATION OF ALL HYDRANTS, STREET LIGHTS, TRANSFORMERS AND OTHER SERVICES. IF MIN. DIMENSIONS ARE NOT MAINTAINED BUILDER IS TO RELOCATE AT HIS OWN EXPENSE.

BUILDING STATISTIC	S
REG. PLAN No.	
ZONE	

LEGI	END	
FINISHED FLOOR	SP	SUMP PUMP
TOP OF FOUNDATION	$\boxtimes$	BELL PEDESTAL
***************************************		CABLE PEDESTAL
		CATCH BASIN
		DBL. CATCH BASIN
REAR	*	ENGINEERED FILL
UNDER SIDE FOOTING @ GARAGE	++	HYDRO CONNECTION
NUMBER OF RISERS TO	Ŷ	FIRE HYDRANT
	SL.	STREET LIGHT
	$\geq \leq$	MAIL BOX
		TRANSFORMER
WALK UP BASEMENT	$\nabla$	SEWER CONNECTIONS 2
REVERSE PLAN	7	SEWER CONNECTIONS 1
STANDARD PLAN	ĭ	WATER CONNECTION
DOOR	Τ	WATER VALVE
WINDOW	•	CHAMBER
AIR CONDITIONING	Ŷ	HYDRANT AND VALVE
DOWN SPOUT TO	H	HYDRO METER
DOWNSPOUT	•	GAS METER
	$\circ$	MANHOLE - STORM
SIGN POST		MANHOLE - SANITARY
- MARKETING LOT NO.		
	FINISHED FLOOR ELEVATION TOP OF FOUNDATION WALL TOP OF BASEMENT SLAB UNDER SIDE FOOTING UNDER SIDE FOOTING WALK UNDER SIDE FOOTING WALKOUT DECK LOOKOUT BASEMENT WALK OUT BASEMENT WALK OUT BASEMENT WALK OUT BASEMENT WALK OUT BASEMENT WALK UP BASEMENT WALK OUT BASEMENT WALK UP BASEMENT WALK UP BASEMENT REVERSE PLAN STANDARD PLAN DOOR WINDOW AIR CONDITIONING DOWN SPOUT TO SPLAST PAD DOWNSPOUT CONNECTED TO STM SWALE DIFECTION SIGN POST	ELEVATION TOP OF FOUNDATION WALL TOP OF BASEMENT SLAB UNDER SIDE FOOTING (a) FEAR UNDER SIDE FOOTING (a) FEAR UNDER SIDE FOOTING (a) FEAR WALKOUT DECK LOOKOUT BASEMENT WALK OUT BASEMENT WALK OUT BASEMENT WALK OUT BASEMENT WALK UP BASEMENT WALK OUT BA

TOC		TO BE EXTEN MIN) BELOW G DEPTH. CO	GRAD ONTRAC	CTOR
	ISSUED OR REVISION CO	OMMENTS	3	
NO.	DESCRIPTION	DATE	DWN	CHK
1	ISSUED FOR REVIEW	15-FEB-25	PP	
2	ISSUED FINAL	20-MAR-25	PP	MSA
3	ISSUED FINAL	26-MAR-25	PP	MSA
4	REVISED TEMPLATE AS PER WD	04-JUNE-25	PP	MSA

—XX——— PRIVACY FENCE

CHAINLINK FENCE



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I, martha sandoval declare that I have reviewed and taken design responsibility for the design work on BEHALF OF RN DESIGN LTD, UNDER DIVISION C, PART-3
SUBSECTION-3.2.4 OF THE BUILDING CODE. I AM QUALIFIED AND THE FIRM IS REGISTERED IN THE APPROPRIATE CLASSES / CATEGORIES.

QUALIFIED DESIGNER BCIN: FIRM BCIN: DATE: JUN-10-2025

KYLEMORE HOMES


YORK DOWNS MARKHAM, ONTARIO PHASE 1A

SITE PLAN

-	
DRAWN BY	SCALE
PP	1:250
PROJECT No.	LOT NUMBER
20011	1



LOT 1 GARAGE DIM. | COVERAGE | LOT AREA | COVERAGE | G.F.A. LOT LOT BUILDING MODEL  $W \times L (m)$ (m2)(m2)FRONTAGE (m DEPTH (m) | HEIGHT (m) (m2)(%) 70-01 LOT SPEC**IFI**C 6.09 X 9.75 256.59 652.75 432.74 22.69 33.01 10.28

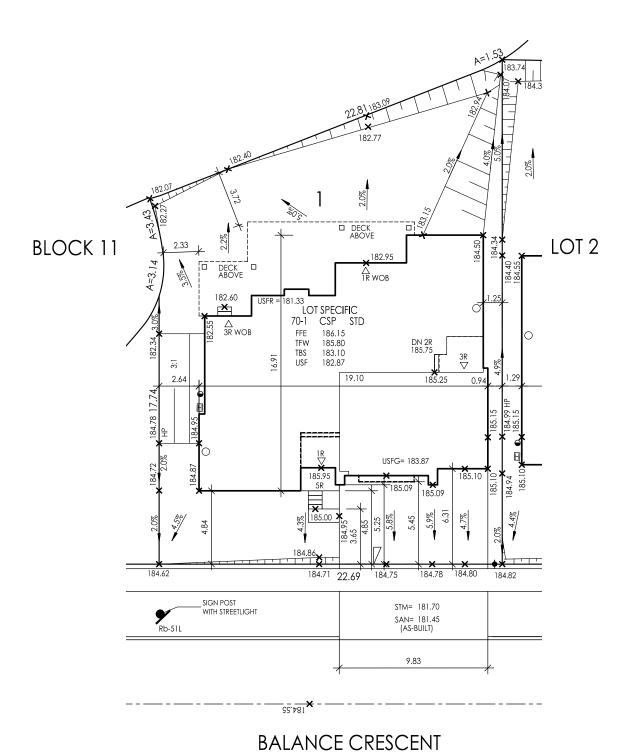

standards.

LOT \_1\_

REVIEWED FOR:

3. Conformance with City of Markham grading

Grade as being in conformity with the drainage concepts shown on the lot grading plans prepared

2. Conformance with the approved composite utility


Date: <u>JUN 06, 2025</u> Reviewed by:


by Stantec Consulting Ltd.

STANTEC CONSULTING LTD.

W Architect Inc. **DESIGN CONTROL REVIEW** JUNE 10, 2025 FINAL BY:

This stamp is only for the purposes of design

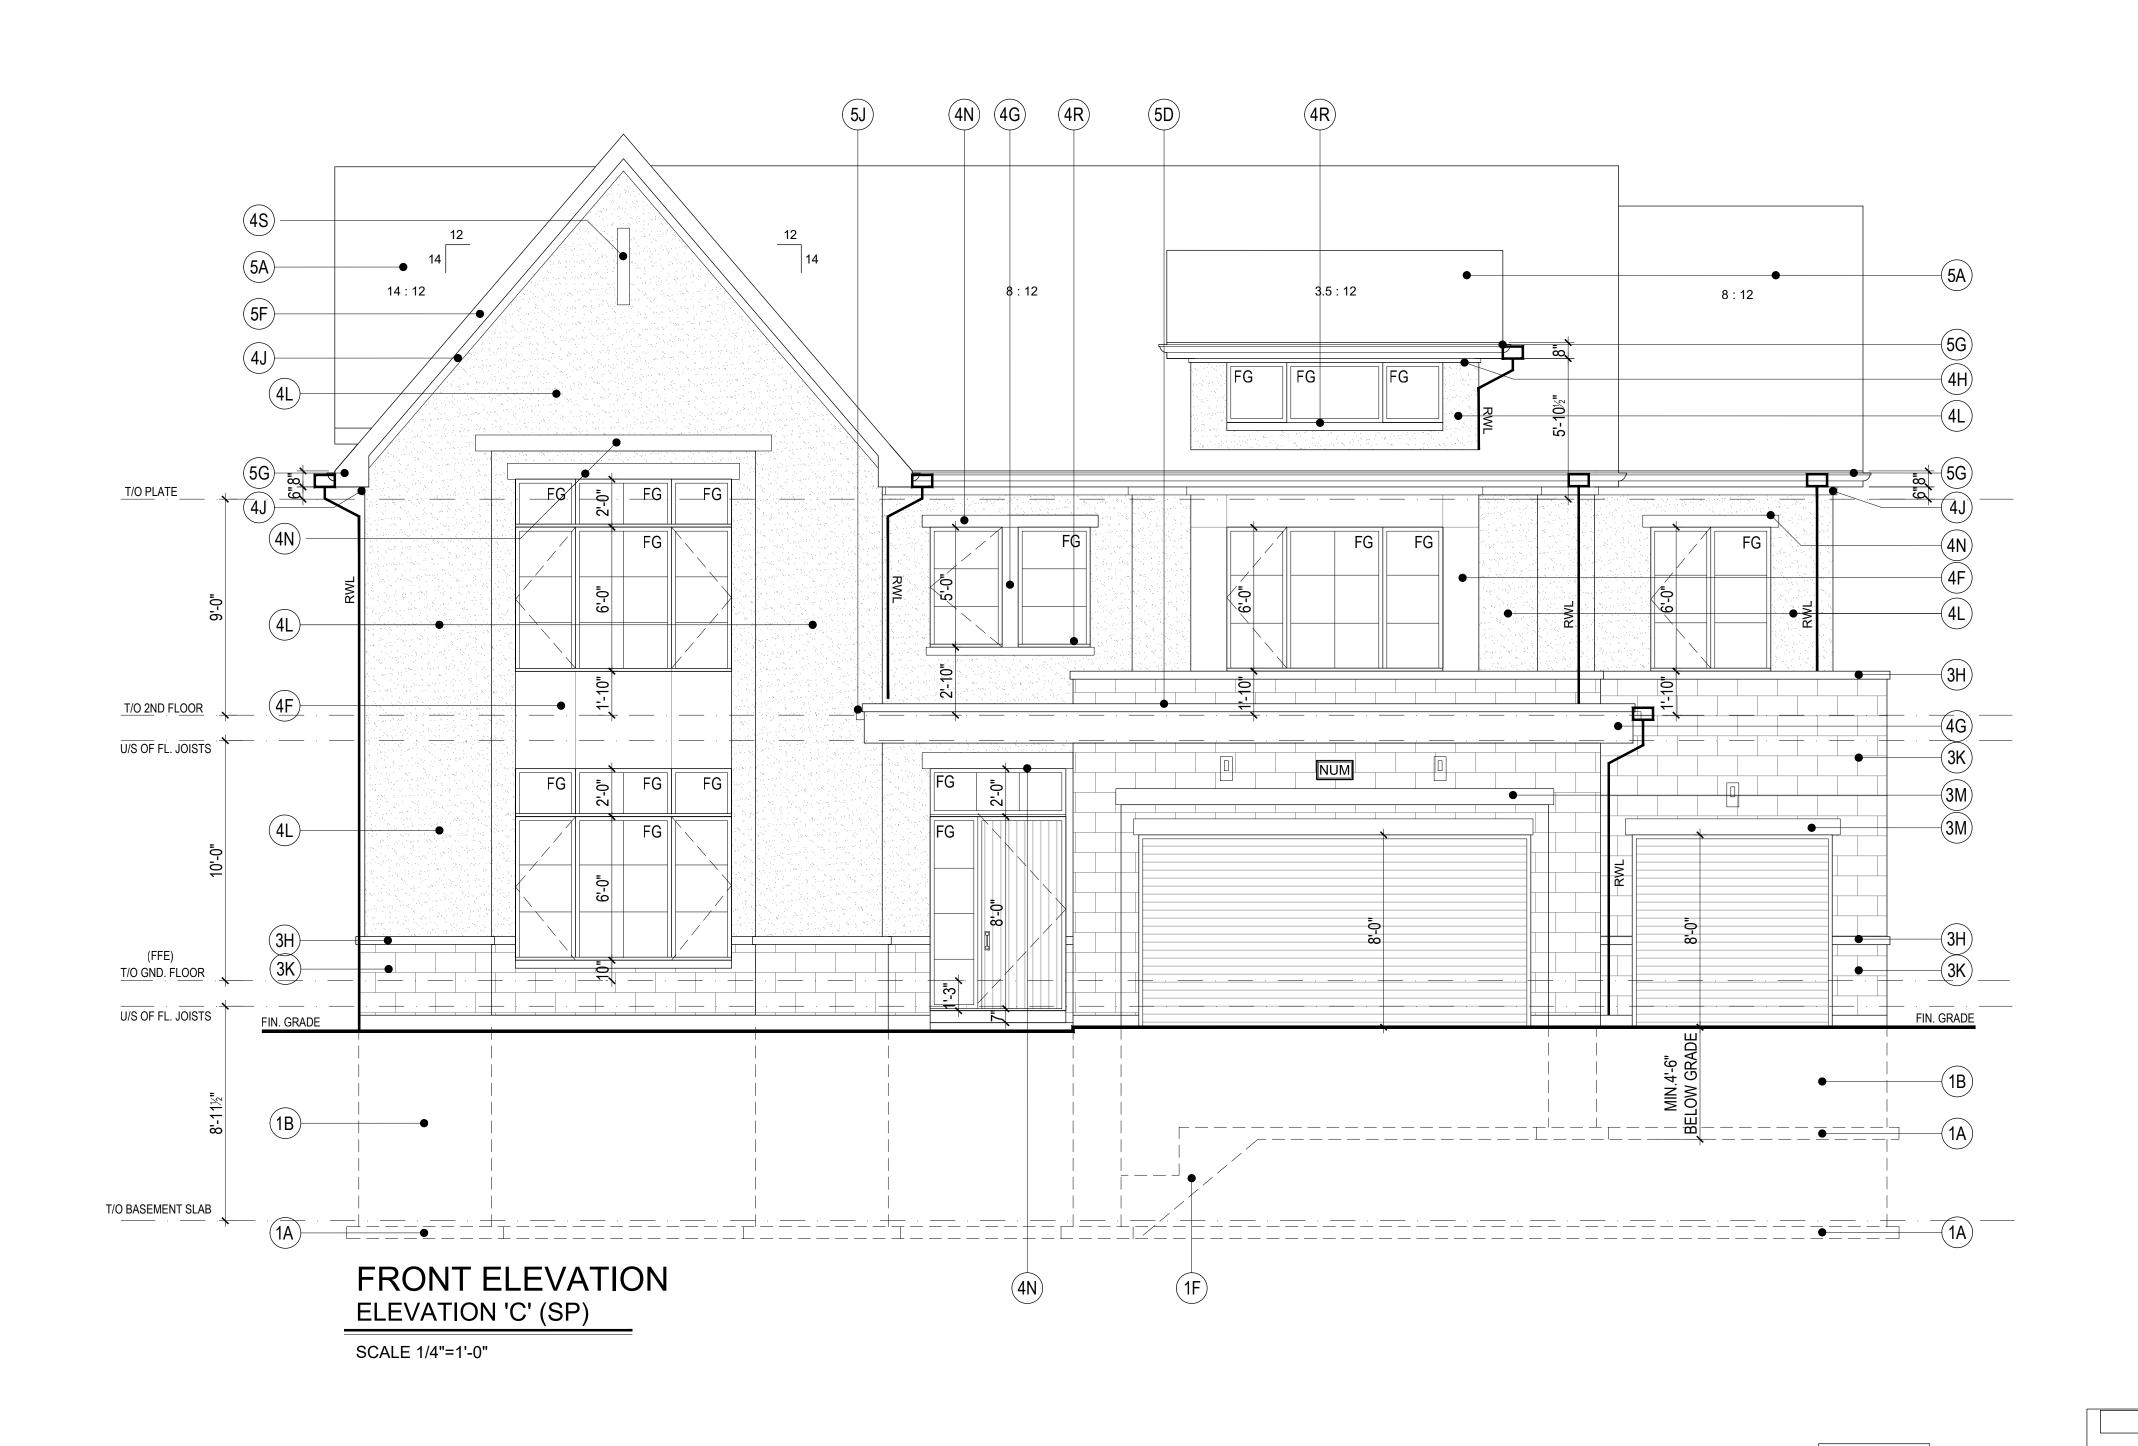

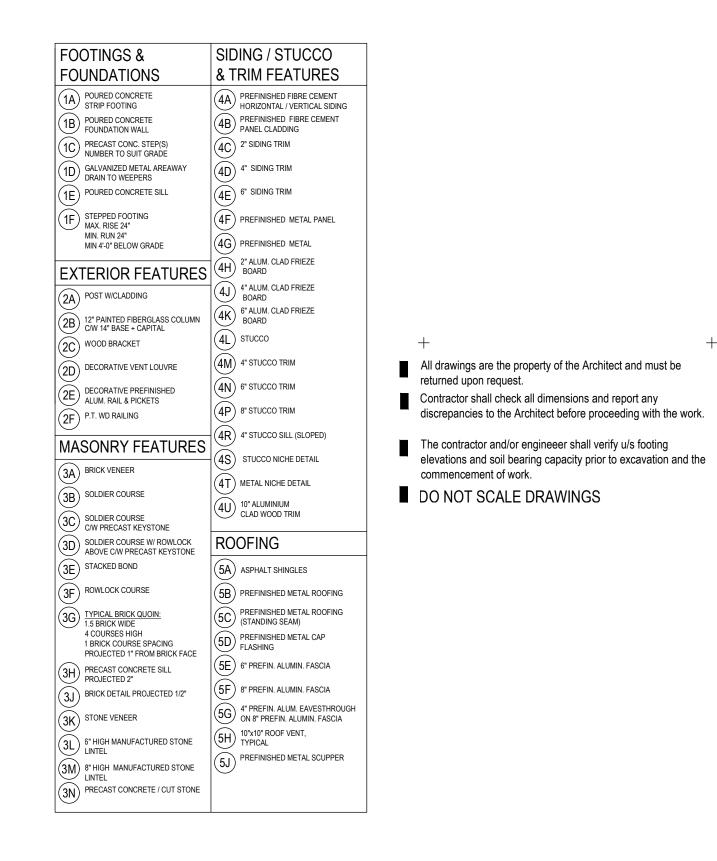

CR 6	JUN 05, 2024	ISSUED FOR PERMIT COORDINATION
CR 5	MAY 02, 2024	ISSUED FOR COORDINATION
CR 4	FEB 26, 2024	ISSUED FOR COORDINATION
CR 3	FEB 07, 2024	ISSUED FOR COORDINATION
CR 2	MAR 13, 2023	ISSUED FOR COORDINATION
CR 1	NOV 08, 2023	ISSUED FOR COORDINATION
no.	date	revision
+	+	+ +



+ +

770 BROWN'S LINE, TORONTO, ON M8W 3W2 - T(416) 252-5679 F(416) 252-9637

KYLEMORE HOMES

10080 KENNEDY ROAD

MARKHAM, ONTARIO

L6C 19N

project
ANGUS GLEN - SOUTH VILLAGE MARKHAM, ONTARIO

MODEL 70-1C (SP) FRONT ELEVATION

DEC 2021 drawn CR

A-6

project number + 20.146

FRONT ELEV "A"

TOTAL EBF AREA= 1079.58 FT2 OR 100.3 M2


ELEV. A: EBF-1 =1079.58 SF = 100.3 m2

LD = 1.2 m

UO % = 30.7% UO = 332.24 SF= 30.9 M2

NOTE: BUILDER TO VERIFY LOCATION OF ALL HYDRANTS, STREET LIGHTS, TRANSFORMERS AND OTHER SERVICES. IF MIN. DIMENSIONS ARE NOT MAINTAINED BUILDER IS TO RELOCATE AT HIS OWN EXPENSE.

BUILDING STATISTIC:	S
REG. PLAN No.	
ZONE	

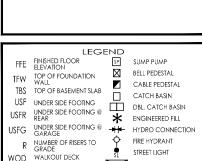

WATER CONNECTION

MANHOLE - STORM MANHOLE - SANITARY

TFW TOP OF FOUNDATION WALL

TBS TOP OF BASEMENT SLAB R NUMBER OF RISERS TO GRADE
WOD WALKOUT DECK MAIL BOX
TRANSFORMER LOB LOOKOUT BASEMENT
WOD WALK OUT BASEMENT SEWER CONNECTIONS 2 WUB WALK UP BASEMENT SEWER CONNECTIONS 1 REV REVERSE PLAN STD STANDARD PLAN  $\triangle$  DOOR WATER VALVE
CHAMBER
HYDRANT AND
VALVE O WINDOW

Ad AIR CONDITIONING DOWN SPOUT TO SPLASH PAD

DOWNSPOUT CONNECTED TO STM

SWALE DIRECTION HYDRO METER SIGN POST

x «	CHAINLINK FENCE
xx	PRIVACY FENCE
xxx s	OUND BARRIER
	OOTING TO BE EXTENDED
İ	O 1.22 (MIN) BELOW GRADE
: USF IS BASED ON 150mm (	S") FOOTÌNG DEPTH. CONTRAC'
	AWINGS FOR SPECIFIC SIZES THA
SUPERSEDE THIS SIZE	

ISSUED OR REVISION COMMENTS				
NO.	DESCRIPTION	DATE	DWN	CHK
1	ISSUED FOR REVIEW	24-AUG-23	RP	
2	ISSUED FINAL	30-OCT-23	RP	
3	REVISED PER ENG COMM	06-FEB-24	RP	
4	REV. PER PM'S COMMENT	26-NOV-24	PP	MSA
5	ISSUED FINAL	09-DEC-24	PP	MSA

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I, JORGE MORENO DECLARE THAT I HAVE REVIEWED AND TAKEN DESIGN RESPONSIBILITY FOR THE DESIGN WORK ON BEHALF OF RN DESIGN LTD, UNDER DIVISION C, PART-3 SUBSECTION-3, 2, 4 OF THE BUILDING CODE. I AM QUALIFIED AND THE FIRM IS REGISTERED IN THE APPROPRIATE CLASSES / CATEGORIES.

QUALIFIED DESIGNER BCIN: FIRM BCIN: DATE:

CLIENT	
	KYLEMORE HOMES


YORK DOWNS MARKHAM, ONTARIO PHASE 1A

SITE PLAN


DRAWN BY	SCALE
RP	1:250
PROJECT No.	LOT NUMBER
20011	2




LOT 2 GARAGE DIM. | COVERAGE | LOT AREA | COVERAGE | G.F.A. LOT LOT AMENITY BUILDING MODEL  $W \times L (m)$ (m2)SPACE (m2) HEIGHT (m) (m2)(m2)(%) FRONTAGE (m) DEPTH (m) 70-01 'B' STD 6.10 X 9.22 287.96 708.17 505.85 21.34 33.01 257.21 9.62

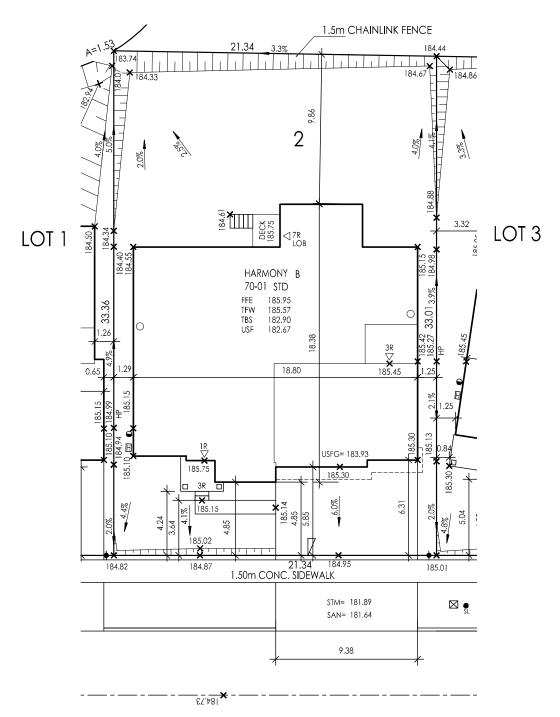

**BALANCE CRESCENT** 

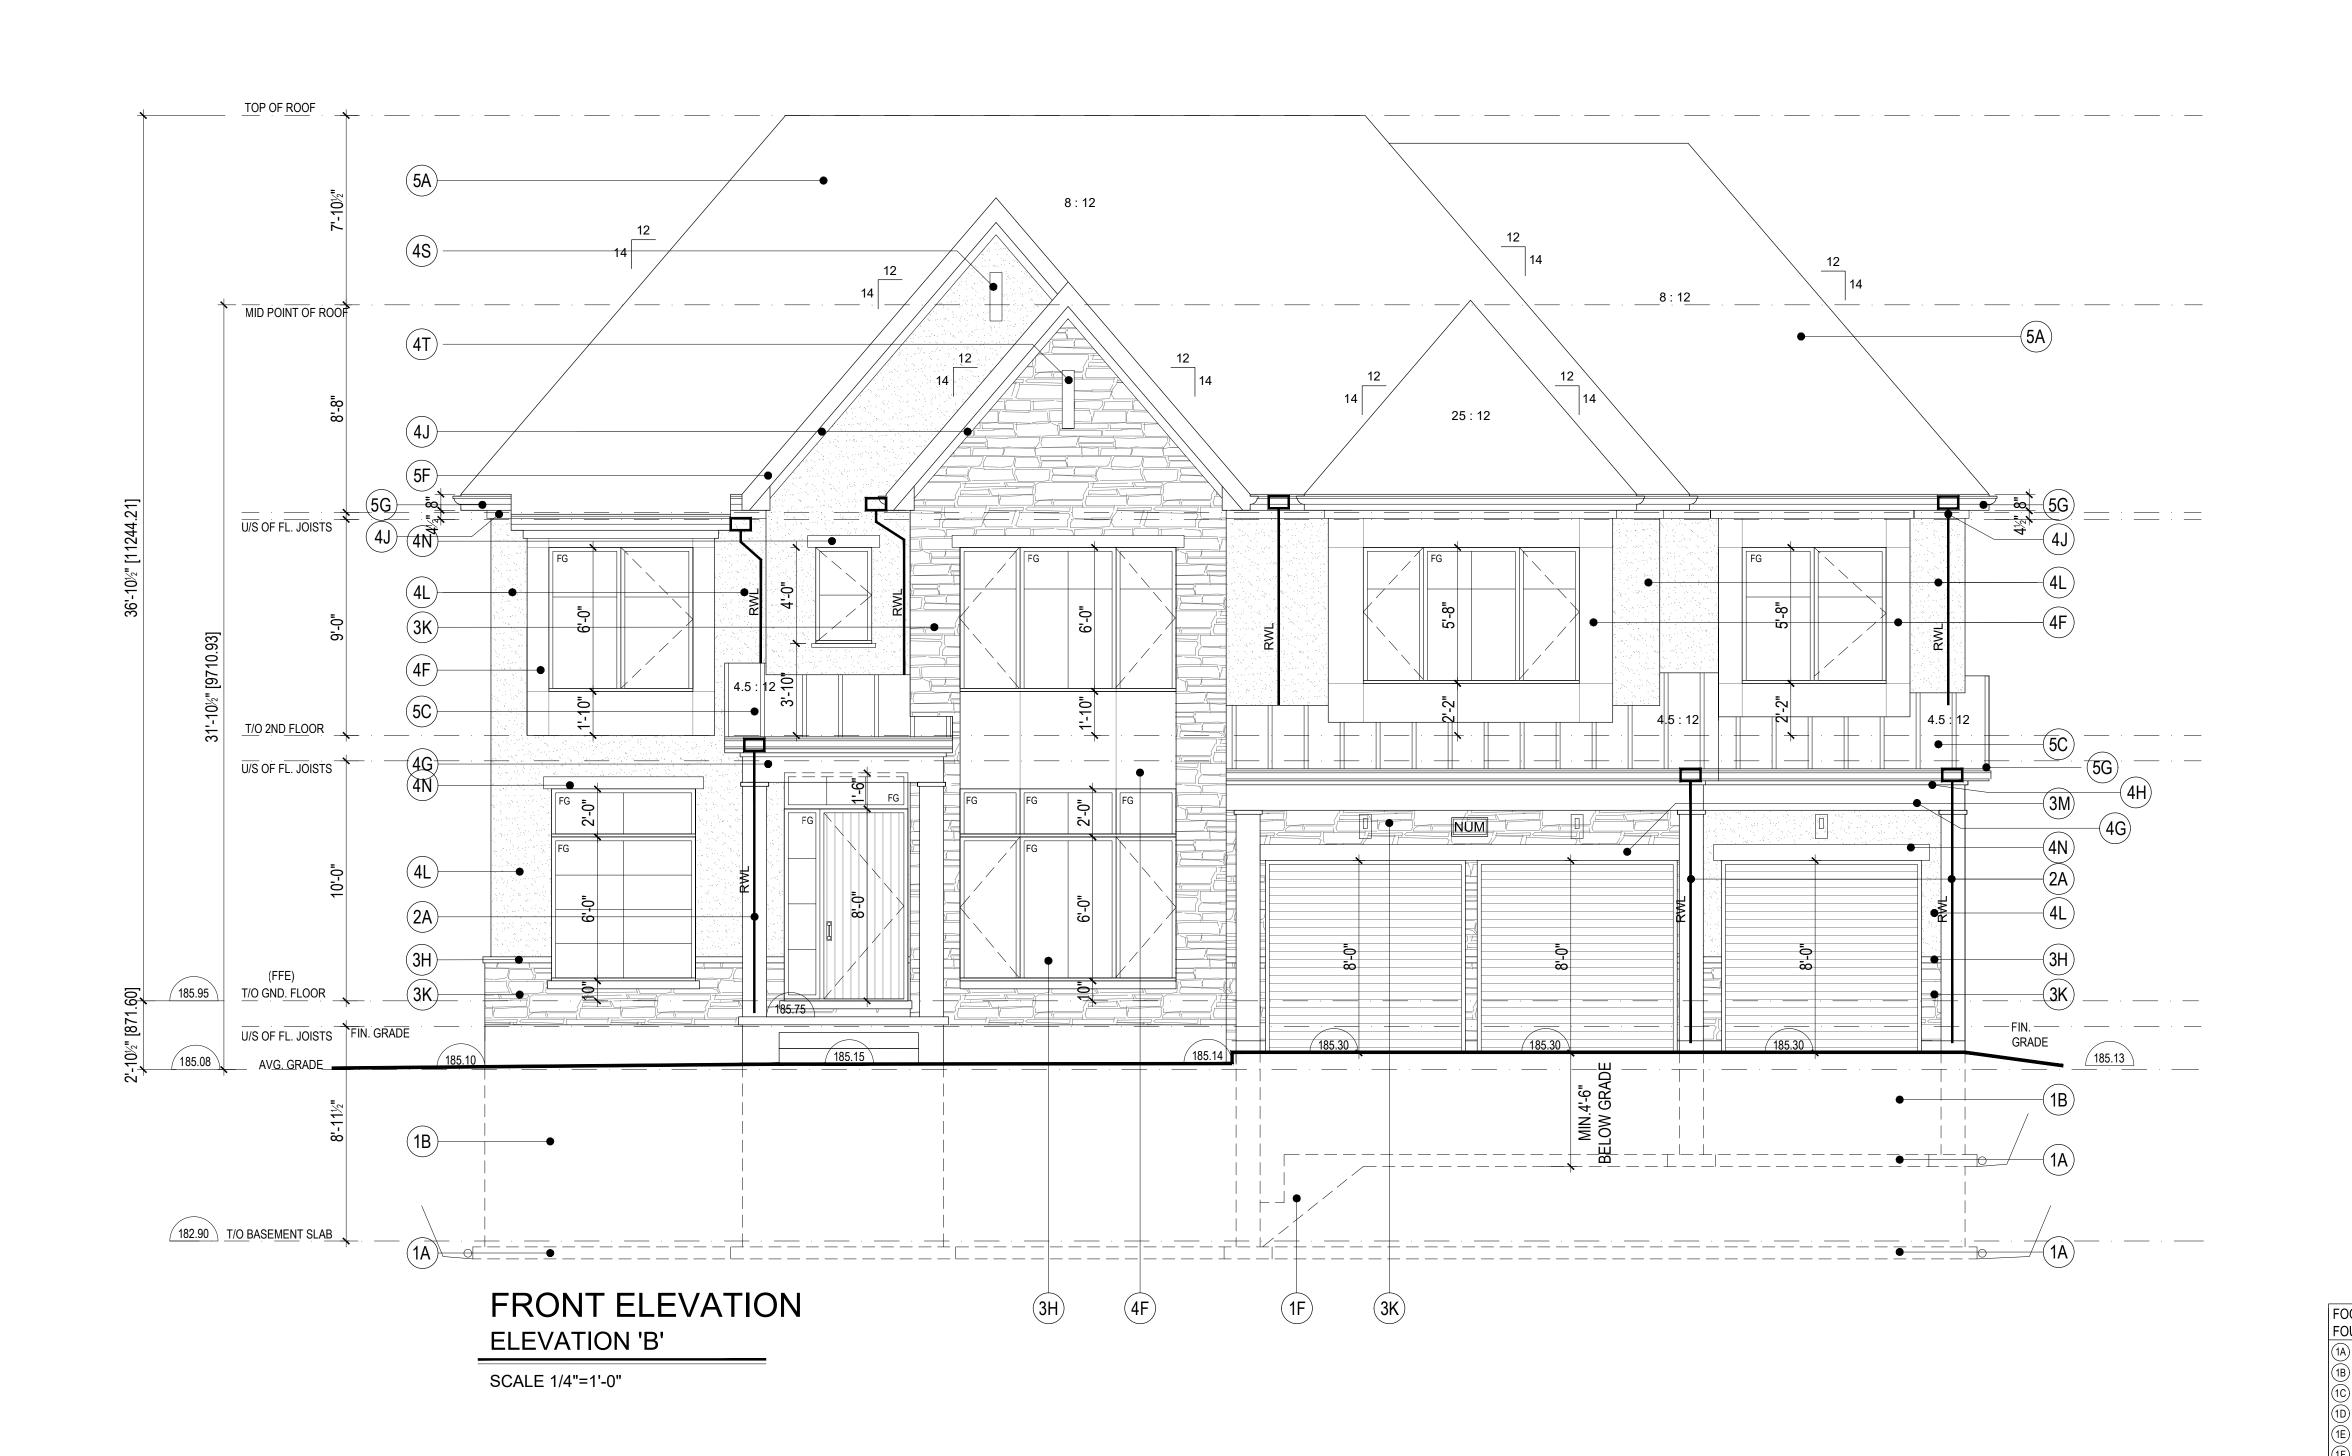


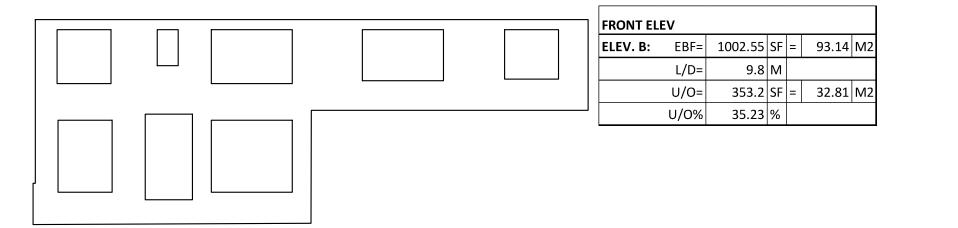


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OTINGS &	SIDING / STUCCO	
JNDATIONS	& TRIM FEATURES	
POURED CONCRETE STRIP FOOTING	PREFINISHED FIBRE CEMENT HORIZONTAL / VERTICAL SIDING	
POURED CONCRETE FOUNDATION WALL	4B) PREFINISHED FIBRE CEMENT PANEL CLADDING	
PRECAST CONC. STEP(S)	4C) 2" SIDING TRIM	
NUMBER TO SUIT GRADE GALVANIZED METAL AREAWAY	4" SIDING TRIM	
DRAIN TO WEEPERS POURED CONCRETE SILL	(4E) 6" SIDING TRIM	
STEPPED FOOTING	4F) PREFINISHED METAL PANEL	
MAX. RISE 24" MIN. RUN 24" MIN 4'-0" BELOW GRADE	(4G) PREFINISHED METAL	770 BR
	2" ALLIM CLAD ERIEZE	
TERIOR FEATURES	(4H) BOARD	
POST W/CLADDING	4" ALUM. CLAD FRIEZE BOARD	
12" PAINTED FIBERGLASS COLUMN C/W 14" BASE + CAPITAL	6" ALUM. CLAD FRIEZE BOARD	
WOOD BRACKET	4L STUCCO	
DECORATIVE VENT LOUVRE	4M 4" STUCCO TRIM	
DECORATIVE PREFINISHED	4N 6" STUCCO TRIM	
ALUM. RAIL & PICKETS P.T. WD RAILING	4P 8" STUCCO TRIM	<u>'</u>
	4" STUCCO SILL (SLOPED)	
SONRY FEATURES	(4S) STUCCO NICHE DETAIL	
BRICK VENEER	(4T) METAL NICHE DETAIL	
SOLDIER COURSE		
SOLDIER COURSE C/W PRECAST KEYSTONE	CLAD WOOD TRIM	I
SOLDIER COURSE W/ ROWLOCK	ROOFING	
ABOVE C/W PRECAST KEYSTONE STACKED BOND	(5A) ASPHALT SHINGLES	
ROWLOCK COURSE		
	(5B) PREFINISHED METAL ROOFING  PREFINISHED METAL ROOFING	
TYPICAL BRICK QUOIN: 1.5 BRICK WIDE	(STANDING SEAM)	1
4 COURSES HIGH 1 BRICK COURSE SPACING	PREFINISHED METAL CAP FLASHING	
PROJECTED 1" FROM BRICK FACE PRECAST CONCRETE SILL	5E 6" PREFIN. ALUMIN. FASCIA	
PROJECTED 2" BRICK DETAIL PROJECTED 1/2"	(5F) 8" PREFIN. ALUMIN. FASCIA	scale
STONE VENEER	4" PREFIN. ALUM. EAVESTHROUGH ON 8" PREFIN. ALUMIN. FASCIA	date
6" HIGH MANUFACTURED STONE	(5H) 10"x10" ROOF VENT,	draw
LINTEL	(5J) PREFINISHED METAL SCUPPER	
8" HIGH MANUFACTURED STONE LINTEL		chk'
PRECAST CONCRETE / CUT STONE		



dı	ving
ľ	IODEL 70-1 (LOT 2)
	FRONT ELEVATIONS
	ELEVATION 'B'

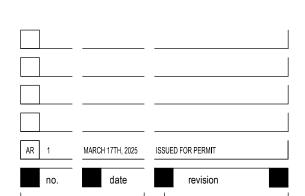NOTE: BUILDER TO VERIFY LOCATION OF ALL HYDRANTS, STREET LIGHTS, TRANSFORMERS AND OTHER SERVICES, IF MIN. DIMENSIONS ARE NOT MAINTAINED BUILDER IS TO RELOCATE AT HIS OWN EXPENSE.

BUILDING STATISTICS			
REG. PLAN No.			
ZONE			

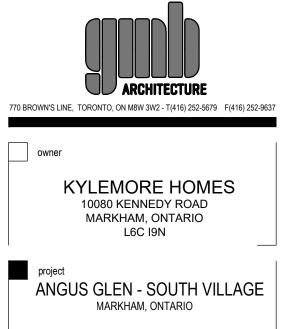

LEGEND R SP FFE FINISHED FLOOR ELEVATION  $\boxtimes$ BELL PEDESTAL TFW TOP OF FOUNDATION WALL

TBS TOP OF BASEMENT SLAB CABLE PEDESTAL USF UNDER SIDE FOOTING BASIN DBL. CATCH BASIN DBL. CATCH BASIN DBL. CATCH BASIN WAS REAR WAS BASIN DBL. CATCH BASIN DBL. CATCH BASIN WAS REAR WAS BASIN DBL. CATCH BASIN DBL. CATCH BASIN WAS BASIN DBL. CATCH BAS FIRE HYDRANT

ST. STREET LIGHT R NUMBER OF RISERS TO GRADE

WOD WALKOUT DECK STREET LIGHT MAIL BOX
TRANSFORMER LOB LOOKOUT BASEMENT
WOB WALK OUT BASEMENT SEWER CONNECTIONS 2 WUB WALK UP BASEMENT SEWER CONNECTIONS 1 REV REVERSE PLAN STD STANDARD PLAN WATER CONNECTION △ DOOR○ WINDOW△ AIR CONDITIONING WATER VALVE
CHAMBER
HYDRANT AND
VALVE DOWN SPOUT TO SPLASH PAD

DOWNSPOUT CONNECTED TO STM

SWALE DIRECTION HYDRO METER MANHOLE - STORM MANHOLE - SANITARY SIGN POST

———X——— CHAINLINK FENCE
———XX——— PRIVACY FENCE
———XXX——— SOUND BARRIER
NOTE: USF IS BASED ON 150mm (6") FOOTING DEPTH. CONTRACTOR
TO CONFIRM WITH WORKING DRAWINGS FOR SPECIFIC SIZES THAT
MAY SUPERSEDE THIS SIZE.

ISSUED OR REVISION COMMENTS				
NO.	DESCRIPTION	DATE	DWN	CHK
1	ISSUED FOR REVIEW	24-AUG-23	RP	
2	ISSUED FINAL	30-OCT-23	RP	
3	REVISED PER ENG COMM	06-FEB-24	RP	
4	REV. PER PM'S COMMENT	26-NOV-24	PP	MSA
5	ISSUED FINAL	09-DEC-24	PP	MSA



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I, JORGE MORENO DECLARE THAT I HAVE REVIEWED AND TAKEN DESIGN RESPONSIBILITY FOR THE DESIGN WORK ON BEHALF OF RN DESIGN LIDJUNDER DIVISION C.PART-3 SUBSECTION-3.2.4 OF THE BUILDING CODE. I AM QUALIFIED AND THE FIRM IS REGISTERED IN THE APPROPRIATE CLASSES / CATEGORIES.

QUALIFIED DESIGNER BCIN: FIRM BCIN: DATE:

47245 26995

GNATURE:


CLIENT	
	KYLEMORE HOMES


YORK DOWNS MARKHAM, ONTARIO PHASE 1A


DRAWING

SITE PLAN

DRAWN BY	SCALE
RP	1:250
PROJECT No. 2001 1	LOT NUMBER

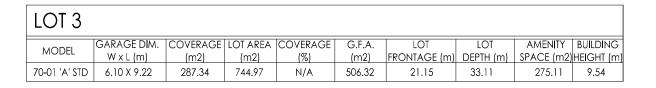

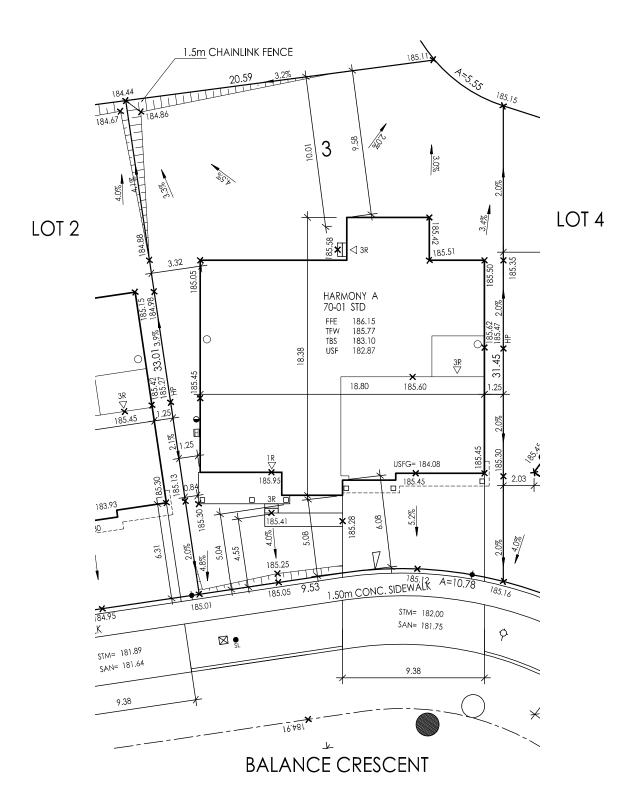

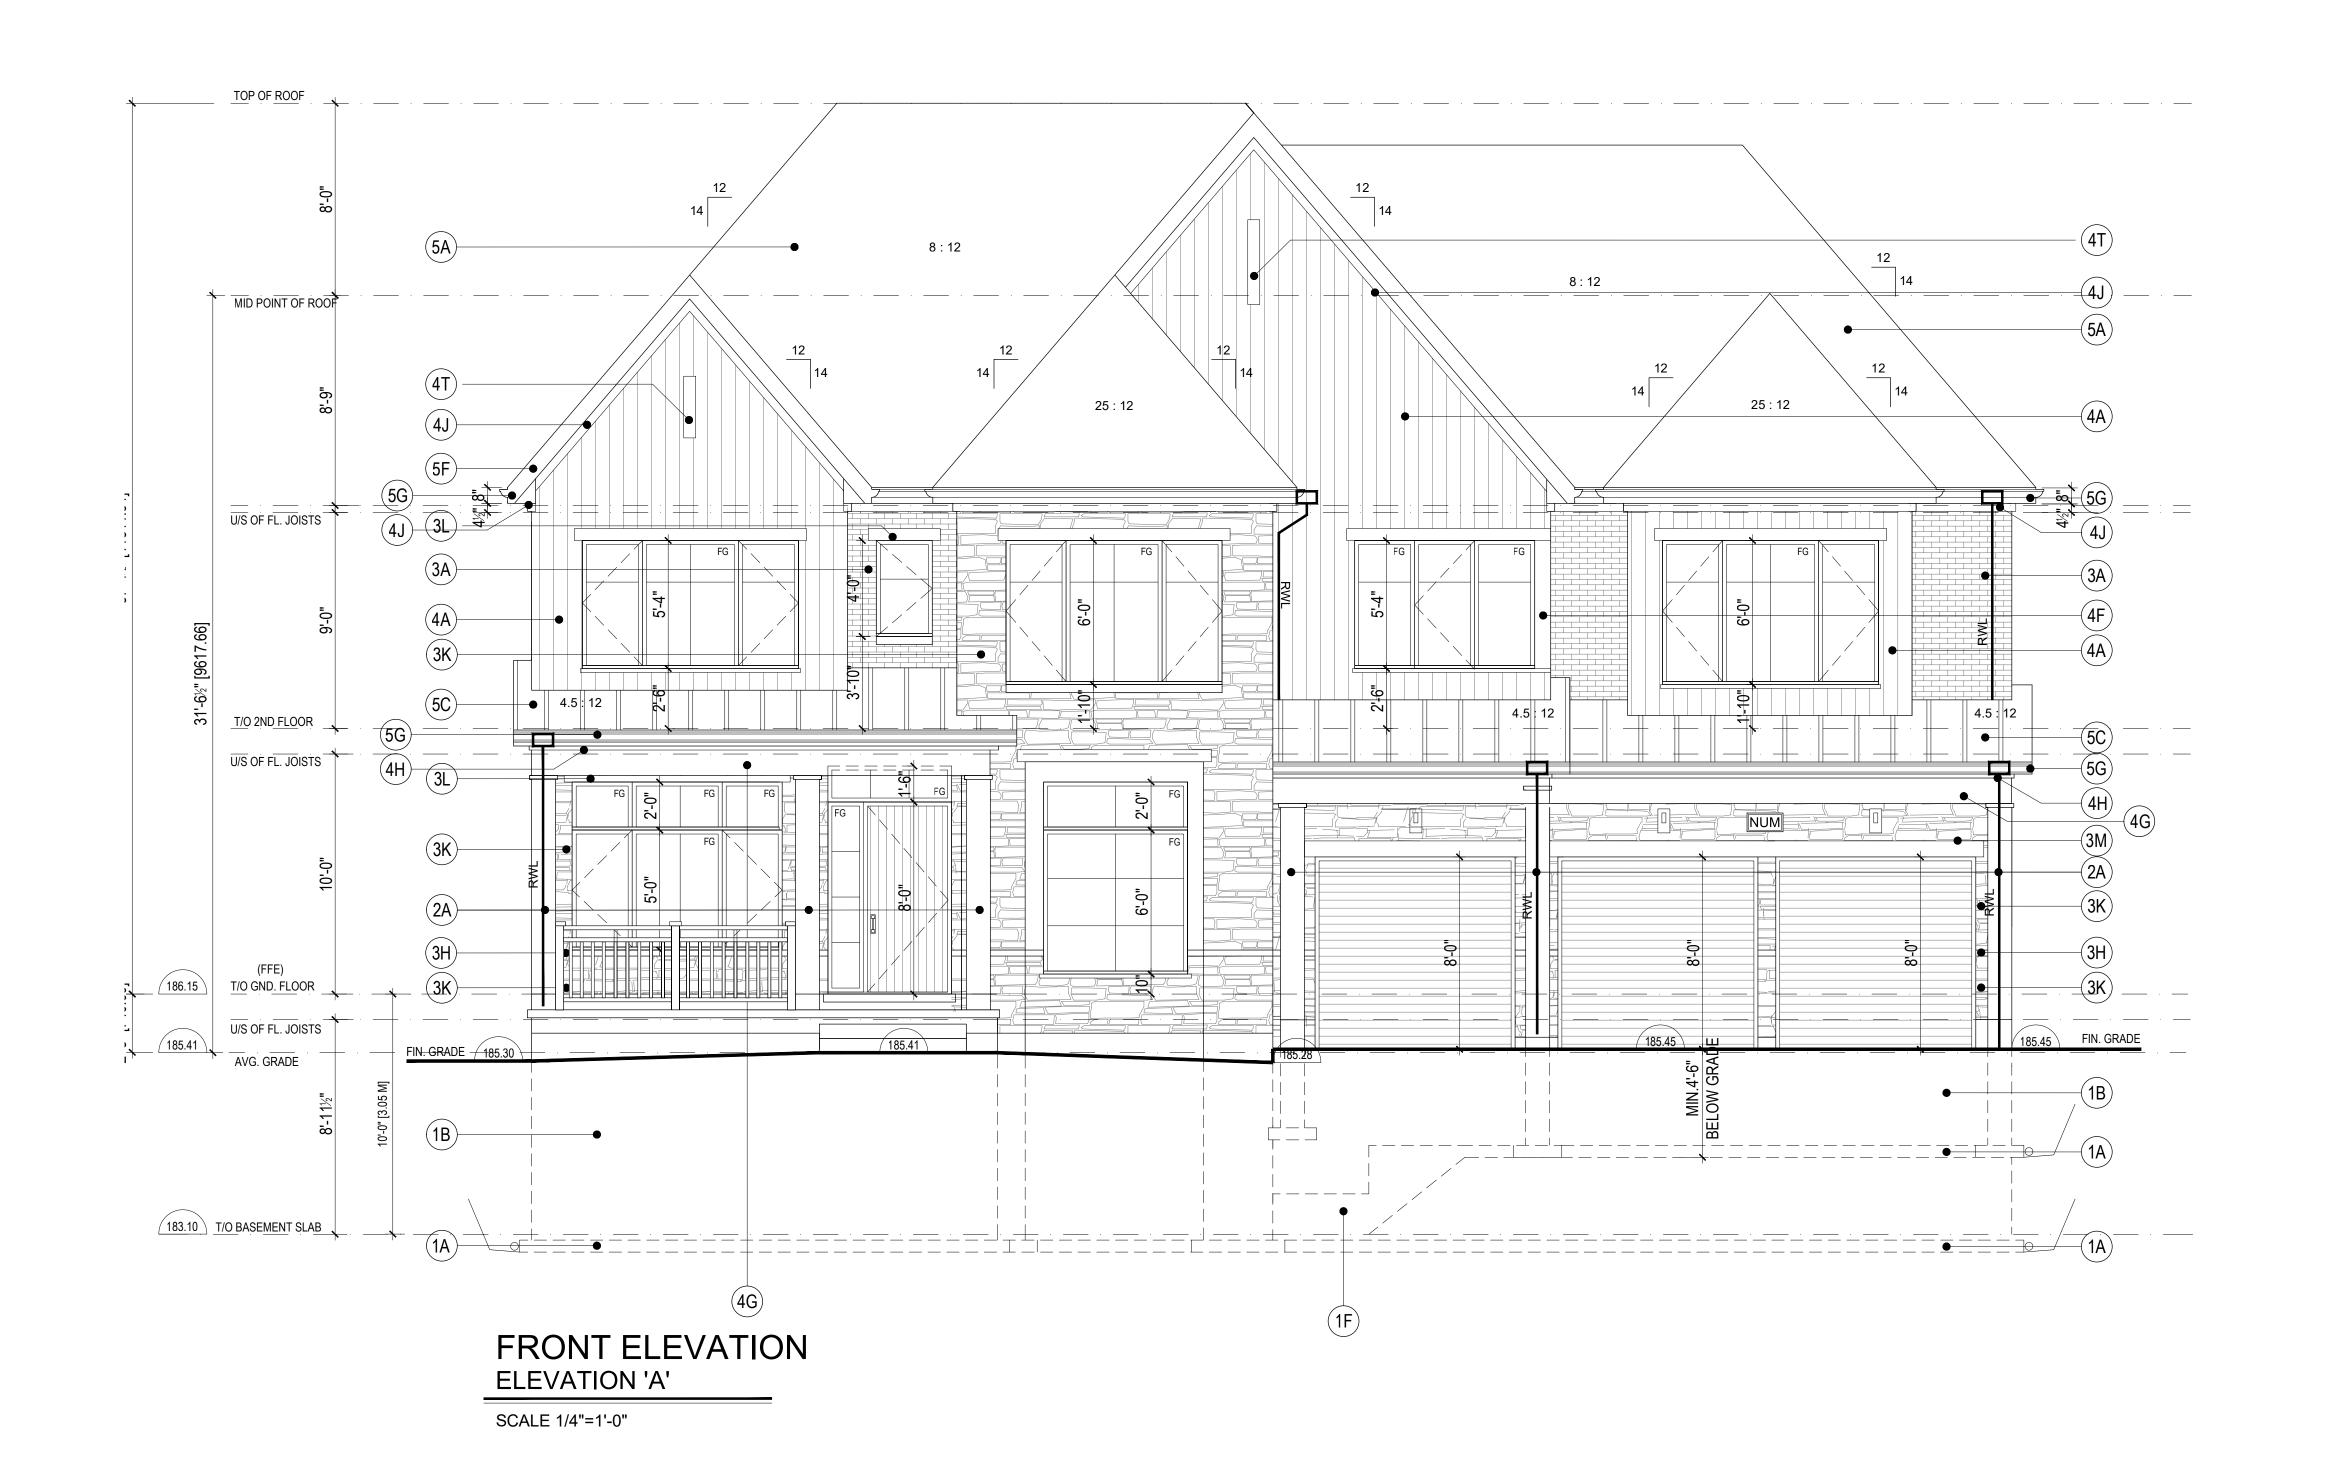


RONT ELEV						
LEV. A:	EBF=	1022.63	SF	=	95.00	M2
	L/D=	5.08	М			
	U/O=	363.56	SF	=	33.78	M2
	U/0%	35.55	%		•	

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FOOTINGS &	SIDING / STUCCO	
FOUNDATIONS	& TRIM FEATURES	+ ++
1A POURED CONCRETE STRIP FOOTING	PREFINISHED FIBRE CEMENT HORIZONTAL / VERTICAL SIDING	
1B POURED CONCRETE FOUNDATION WALL	PREFINISHED FIBRE CEMENT PANEL CLADDING	
1C PRECAST CONC. STEP(S) NUMBER TO SUIT GRADE	4C) 2" SIDING TRIM	
1D GALVANIZED METAL AREAWAY DRAIN TO WEEPERS	4" SIDING TRIM	
1E) POURED CONCRETE SILL	4E) 6" SIDING TRIM	
1F STEPPED FOOTING MAX. RISE 24"	4F) PREFINISHED METAL PANEL	ARCHITECTURE
MIN. RUN 24" MIN 4'-0" BELOW GRADE	4G PREFINISHED METAL	290 QUEEN STREET - UNIT 220, TORONTO, ON M9C 5L2 - T(416) 252-5679
EXTERIOR FEATURES	2" ALUM. CLAD FRIEZE BOARD	
2A) POST W/CLADDING	4" ALUM. CLAD FRIEZE BOARD	owner
12" PAINTED FIBERGLASS COLUMN	6" ALUM. CLAD FRIEZE BOARD	
C/W 14" BASE + CAPITAL  WOOD BRACKET	4L STUCCO	KYLEMORE HOMES
2D) DECORATIVE VENT LOUVRE	4" STUCCO TRIM	10080 KENNEDY ROAD MARKHAM, ONTARIO
2E) DECORATIVE PREFINISHED ALUM. RAIL & PICKETS	4N 6" STUCCO TRIM	L6C 19N
2F) P.T. WD RAILING	4P 8" STUCCO TRIM	
MASONRY FEATURES	4" STUCCO SILL (SLOPED)	project
	4S STUCCO NICHE DETAIL	ANGUS GLEN - SOUTH VILLAGE MARKHAM, ONTARIO
3A)	4T METAL NICHE DETAIL	MARKHAW, ONTARIO
3B)	4U 10" ALUMINIUM CLAD WOOD TRIM	
C/W PRECAST KEYSTONE	DOOFING	
3D) SOLDIER COURSE W/ ROWLOCK ABOVE C/W PRECAST KEYSTONE	ROOFING	drawing
3E) STACKED BOND	(5A) ASPHALT SHINGLES	MODEL 70-1(A)(LOT 3)
3F) ROWLOCK COURSE	(5B) PREFINISHED METAL ROOFING	FRONT ELEVATION
TYPICAL BRICK QUOIN:  1.5 BRICK WIDE  1.5 BRICK WIDE	PREFINISHED METAL ROOFING (STANDING SEAM)	ELEVATION 'A' —
4 COURSES HIGH 1 BRICK COURSE SPACING PROJECTED 1" FROM BRICK FACE	PREFINISHED METAL CAP FLASHING	
3H) PRECAST CONCRETE SILL PROJECTED 2"	6" PREFIN. ALUMIN. FASCIA	
3J) BRICK DETAIL PROJECTED 1/2"	(5F) 8" PREFIN. ALUMIN. FASCIA	<u></u>
3K) STONE VENEER	4" PREFIN. ALUM. EAVESTHROUGH ON 8" PREFIN. ALUMIN. FASCIA	date   DEC 2021   -
3L 6" HIGH MANUFACTURED STONE	5H) 10"x10" ROOF VENT, TYPICAL	drawn CR
3M) 8" HIGH MANUFACTURED STONE	PREFINISHED METAL SCUPPER	chk'd BB
3N) PRECAST CONCRETE / CUT STONE		'
		project number + 20.146
		+

NOTE: BUILDER TO VERIFY LOCATION OF ALL HYDRANTS, STREET LIGHTS, TRANSFORMERS AND OTHER SERVICES, IF MIN. DIMENSIONS ARE NOT MAINTAINED BUILDER IS TO RELOCATE AT HIS OWN EXPENSE.

BUILDING STATISTICS	S
REG. PLAN No.	
ZONE	

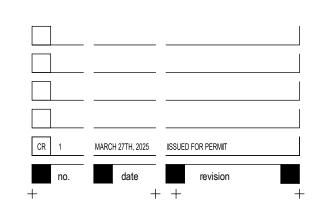	LEGI		
FFE	FINISHED FLOOR ELEVATION	SP	SUMP PUMP
TFW	TOP OF FOUNDATION	$\boxtimes$	BELL PEDESTAL
TBS	TOP OF BASEMENT SLAB		CABLE PEDESTAL
USF	UNDER SIDE FOOTING	부	CATCH BASIN
USFR	UNDER SIDE FOOTING @	Щ	DBL, CATCH BASIN
	REAR UNDER SIDE FOOTING @	*	ENGINEERED FILL
USFG	GARAGE	***	HYDRO CONNECTION
R	NUMBER OF RISERS TO GRADE	Ŷ	FIRE HYDRANT
WOD	WALKOUT DECK	SL	STREET LIGHT
LOB	LOOKOUT BASEMENT	$\cong$	MAIL BOX
WOB	WALK OUT BASEMENT	lacksquare	TRANSFORMER
WUB	WALK UP BASEMENT	$\vee$	SEWER CONNECTIONS 2 LOTS
REV	REVERSE PLAN	7	SEWER CONNECTIONS 1
STD	STANDARD PLAN	,	WATER CONNECTION
Δ	DOOR	Á	WATER VALVE
0	WINDOW	•	CHAMBER
AC	AIR CONDITIONING		HYDRANT AND VALVE
ⅎ	DOWN SPOUT TO SPLASH PAD	H	HYDRO METER
٥	DOWNSPOUT	•	GAS METER
<b>→</b>	CONNECTED TO STM SWALE DIRECTION	$\bigcirc$	manhole - Storm
_	SIGN POST		manhole - Sanitary
	———×——— c	HAINLIN	NK FENCE
		RIVACY	
		DUND B DOTING	FARRIER TO BE EXTENDED
NOTE: !!		D 1.22 (	MIN) BELOW GRADE
	PIRM WITH WORKING DRA		
MAY SUF	PERSEDE THIS SIZE.		

	ISSUED OR REVISION COMMENTS				
NO.	DESCRIPTION	DATE	DWN	СНК	
1	ISSUED FOR REVIEW	24-AUG-23	RP		
2	ISSUED FINAL	30-OCT-23	RP		
3	REVISED PER ENG COMM	06-FEB-24	RP		
4	RE-SITE PER ELEV C	15-NOV-24	PP		
5	REV. PER PM'S COMMENT	26-NOV-24	PP	M\$A	
6	ISSUED FINAL	09-DEC-24	PP	MSA	

DESIGN

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I, JORGE MORENO DECLARE THAT I HAVE REVIEWED AND TAKEN DESIGN RESPONSIBILITY FOR THE DESIGN WORK ON BEHALF OF RN DESIGN LIU, UNDER DIVISION C,PART-3 SUBSECTION-3,2,4 OF THE BUILDING CODE. I AM QUALIFIED AND THE FIRM IS REGISTERED IN THE APPROPRIATE CLASSES / CATEGORIES.

QUALIFIED DESIGNER BCIN: FIRM BCIN: DATE:

47245 26995

GNATURE:

KYLEMORE HOMES
PROJECT/LOCATION
YORK DOWNS
MARKHAM, ONTARIO

DRAWING


SITE PLAN


PHASE 1A

DRAWN BY	SCALE
RP	1:250
PROJECT No. 2001 1	LOT NUMBER  4



LOT 4									
MODEL	GARAGE DIM.	COVERAGE	LOT AREA	COVERAGE	G.F.A.	LOT	LOT	AMENITY	BUILDING
	W x L (m)	(m2)	(m2)	(%)	(m2)	FRONTAGE (m)	DEPTH (m)	SPACE (m2)	HEIGHT (m)
70-01 'C' STD	6.10 x 9.22	292.95	941.77	N/A	482.91	22.43	31.45	398.22	9.61

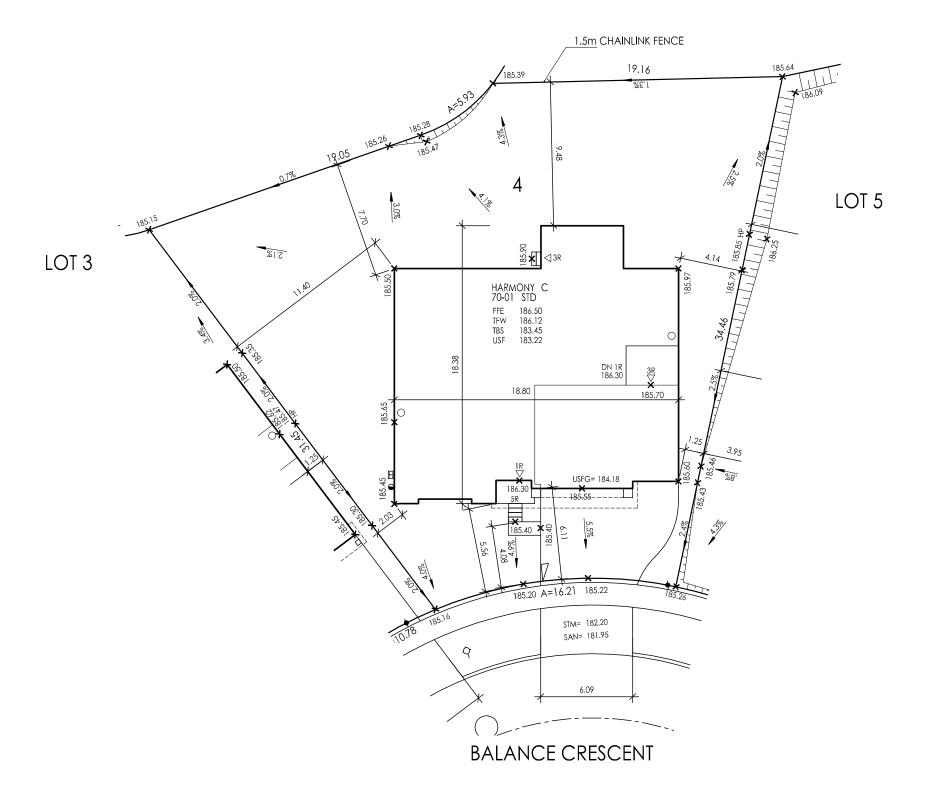


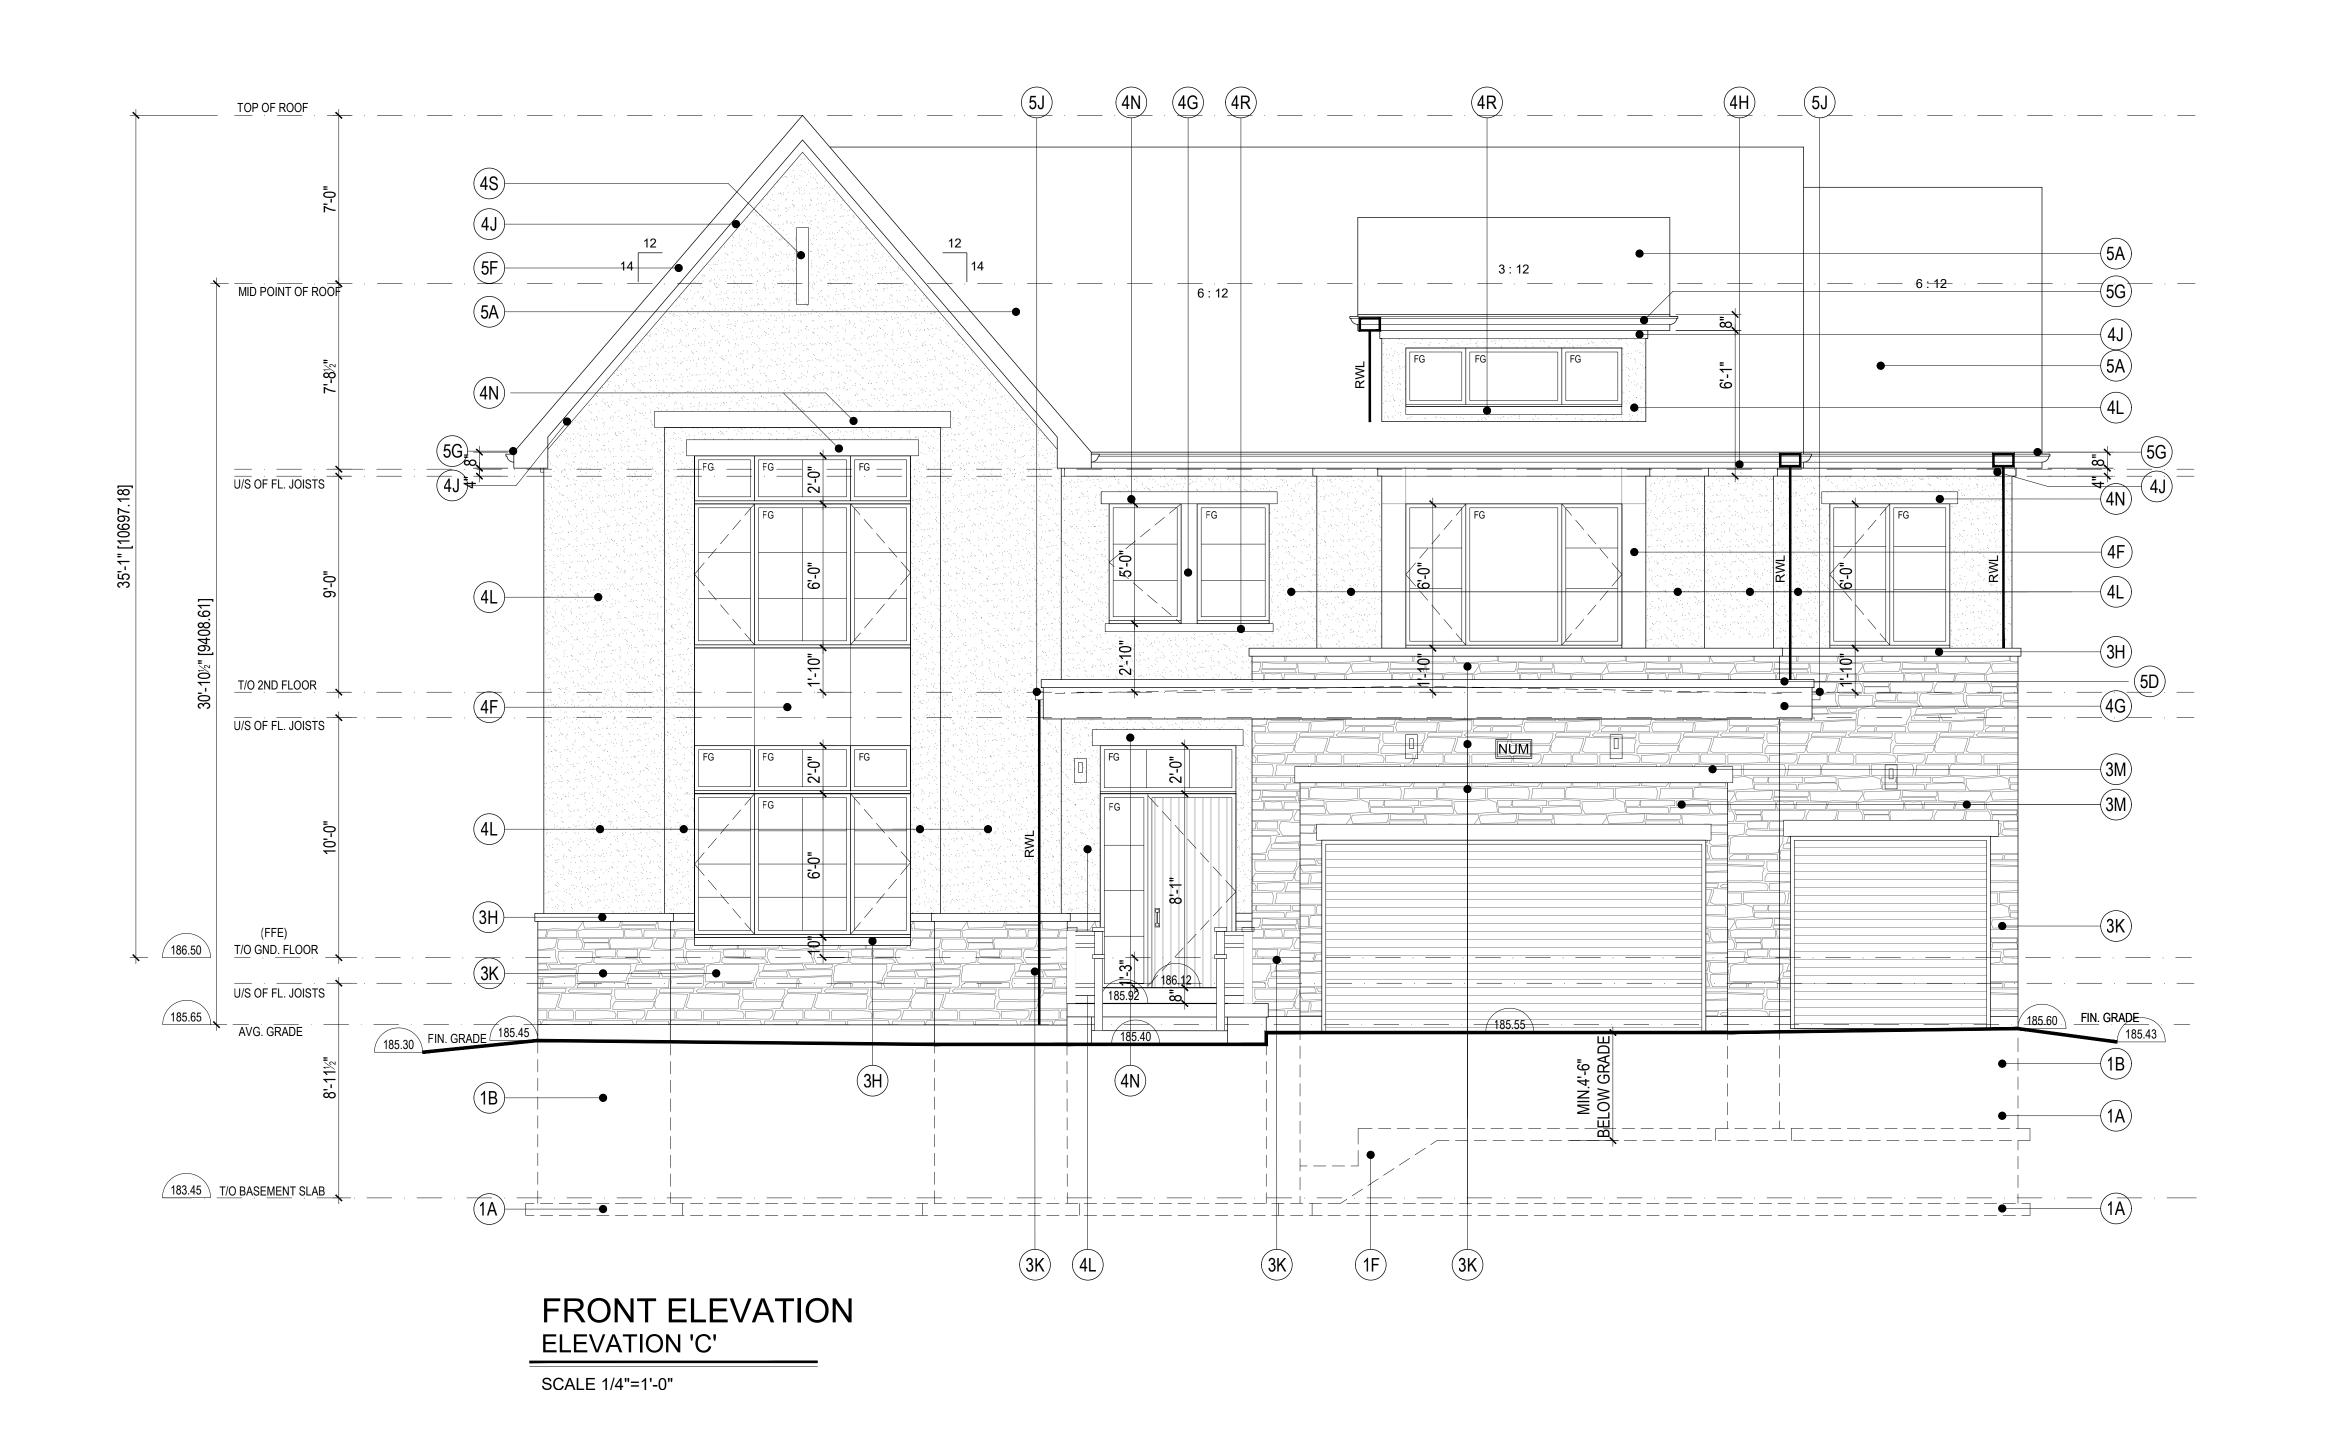


FRONT ELEV **ELEV. C:** EBF= 1116.46 SF = 103.72 M2 L/D= 5.56 M U/O= 336.747 SF = 31.28 M2 U/O% 30.16 %

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BUILDING STATISTICS						
REG. PLAN No.						
ZONE						

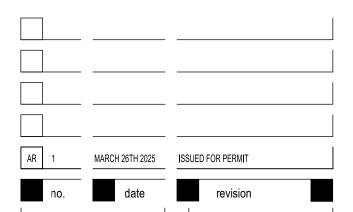

LEGEND R SP DATION FFE FINISHED FLOOR ELEVATION BELL PEDESTAL TFW TOP OF FOUNDATION WALL
TBS TOP OF BASEMENT SLAB CABLE PEDESTAL TBS TOP OF BASEMENT SLAB

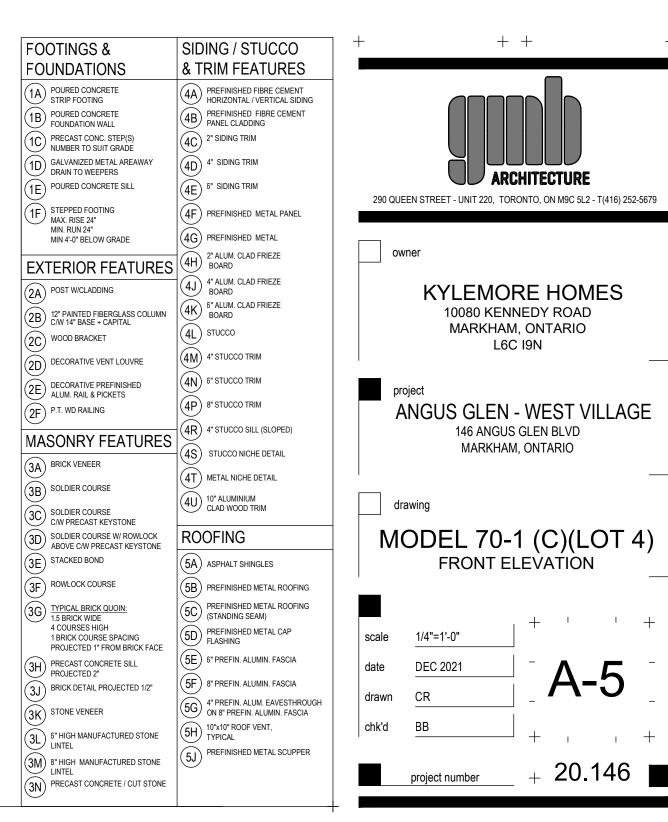USF UNDER SIDE FOOTING

USFR LATCH BASIN

USFR LATCH BASIN

USFR LATCH BASIN

DBL. CATCH BASIN

DBL. CATCH BASIN

BRINGERED FILL

HYDRO CONNECTION

GRADE

WOD WALKOUI DECK

LATCH BASIN

FIRE HYDRO CONNECTION

FIRE HYDRANT

STREET LIGHT R NUMBER OF RISERS TO GRADE
WOD WALKOUT DECK MAIL BOX
TRANSFORMER
SEWER CONNECTIONS 2
LOTS LOB LOOKOUT BASEMENT
WOB WALK OUT BASEMENT WUB WALK UP BASEMENT SEWER CONNECTIONS 1 LOT REV REVERSE PLAN STD STANDARD PLAN WATER CONNECTION A DOOR
O WINDOW
AG AIR CONDITIONING WATER VALVE
CHAMBER
HYDRANT AND
VALVE DOWN SPOUT TO SPLASH PAD

DOWNSPOUT CONNECTED TO STM

SWALE DIRECTION HYDRO METER MANHOLE - STORM MANHOLE - SANITARY SIGN POST

——————————————————————————————————————	CHAINLINK FENCE PRIVACY FENCE SOUND BARRIER FOOTING TO BE EXTENDED TO 1.22 (MIN) BELOW GRADE (8") FOOTING DEPTH. CONTRACT RAWINGS FOR SPECIFIC SIZES THAT
UPERSEDE THIS SIZE.	

	ISSUED OR REVISION COMMENTS								
NO.	DESCRIPTION	DATE	DWN	СНК					
1	ISSUED FOR REVIEW	24-AUG-23	RP						
2	ISSUED FINAL	30-OCT-23	RP						
3	REVISED PER ENG COMM	06-FEB-24	RP						



WWW RNDESIGN COM T:905-738-3177 WWW.THEPLUSGROUP.CA

I, JORGE MORENO DECLARE THAT I HAVE REVIEWED AND TAKEN DESIGN RESPONSIBILITY FOR THE DESIGN WORK ON BEHALF OF RN DESIGN LTD,UNDER DIVISION C,PART-3 SUBSECTION-3.2.4 OF THE BUILDING CODE. I AM QUALIFIED AND THE FIRM IS REGISTERED IN THE APPROPRIATE CLASSES / CATEGORIES.

QUALIFIED DESIGNER BCIN: FIRM BCIN: DATE:

CLIENT					
	ΚYΙ	FMC	)RF	HO	MES


YORK DOWNS MARKHAM, ONTARIO PHASE 1A

SITE PLAN


DRAWN BY	SCALE
RP	1:250
PROJECT No.	LOT NUMBER
20011	59



LOT 59									
MODEL	GARAGE DIM.	COVERAGE	LOT AREA	COVERAGE	G.F.A.	LOT	LOT	AMENITY	BUILDING
	W x L (m)	(m2)	(m2)	(%)	(m2)	FRONTAGE (m)	DEPTH (m)	SPACE (m2)	HEIGHT (m)
70-01 C	9.22 X 6.10	292.95	664.88	N/A	482.91	21.34	31.16	215.24	9.42

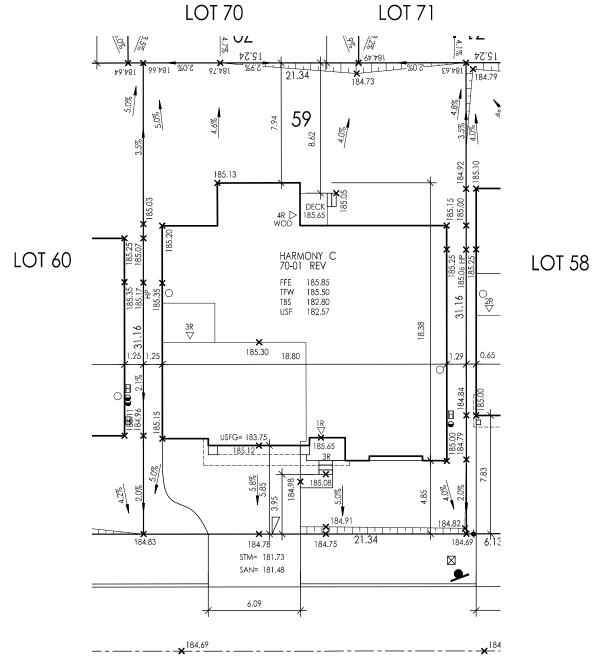

TRANQUILITY CRESCENT

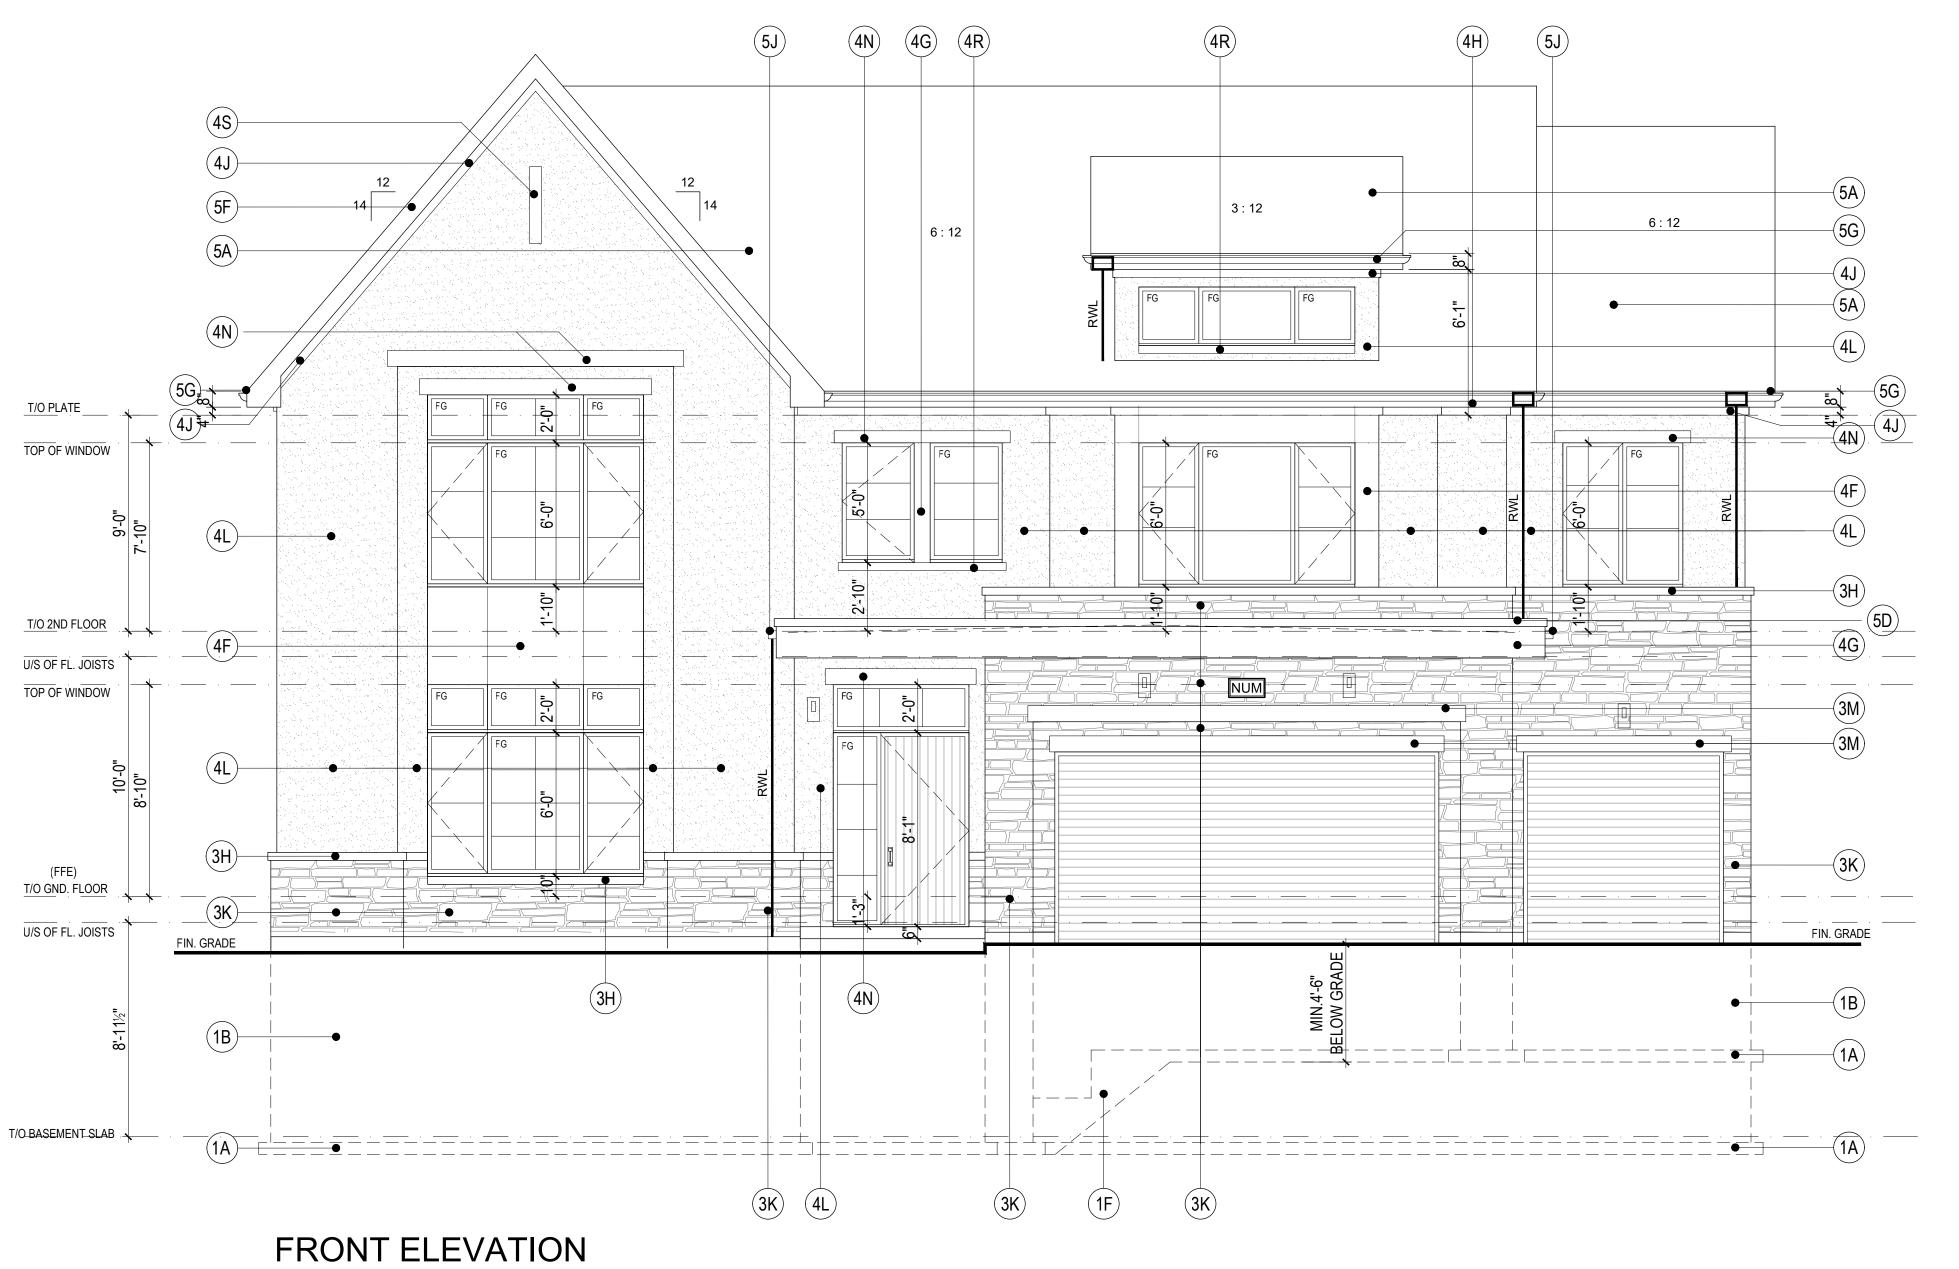

ELEVATION 'C'

SCALE 1/4"=1'-0"

All drawings are the property of the Architect and must be returned upon request.

Contractor shall check all dimensions and report any discrepancies to the Architect before proceeding with the work.

The contractor and/or engineeer shall verify u/s footing elevations and soil bearing capacity prior to excavation and the

commencement of work.

