

Memorandum to the City of Markham Committee of Adjustment

September 5, 2025

File: A/084/25
Address: 76 Highland Park Boulevard, Thornhill
Agent: Aleksandar Markovic
Hearing Date: Wednesday, September 10, 2025

The following comments are provided on behalf of the West Team:

The applicant is requesting relief from the following requirements of By-law 2024-19, Residential - Established Neighbourhood Low Rise (RES-ENLR), as amended, to permit:

a) By-law 2024-19, Section 6.3.2.2.1:

a minimum west side yard setback of 1.52 m and a minimum combined interior side yard setback on both sides of 3.36 m, whereas the by-law requires a minimum side yard setback of 1.8 m and a minimum combined interior side yard setback on both sides of 4.0 m;

b) By-law 2024-19, Section 6.2.1b):

a maximum roof projection of 2.54 m above the maximum outside wall height, whereas the by-law permits a roof structure with a pitch of less than 25 degrees to project a maximum of 1 m above the maximum outside wall height;

c) By-law 2024-19, Section 6.3.2.2.c:

a maximum main building coverage of 24% for any storey above the first, whereas the by-law permits a maximum main building coverage of 20% for any storey above the first;

as it relates to a proposed two-storey residential dwelling.

BACKGROUND

Property Description

The 650 m² (6996.54 ft²) subject property is located on the north side of Highland Park Boulevard, north of Steeles Avenue and east of Yonge Street. The property is located within an established residential neighbourhood comprised of a mix of one and two-storey detached dwellings. The surrounding area is undergoing a transition with newer dwellings being developed as infill developments. Mature vegetation exists across the property.

Proposal

The Owner is proposing to demolish the existing one-storey dwelling and construct a two-storey dwelling on the subject property. To facilitate this, the existing front porch and sheds within the east side yard and rear side yard will also be demolished. The driveway is expected to be regraded and extended from its original location.

Official Plan and Zoning

Official Plan 2014 (partially approved on November 24/17, and updated on July 17/24)

The Official Plan designates the subject property “Residential Low Rise”, which provides for a range of lower-scale residential buildings in established neighbourhoods, including single detached dwellings.

Area Specific Policy 9.18.5 also applies to the Subject Property and intends to provide a set of development standards in the zoning by-law that limits the size and massing of new dwellings or additions, ensuring infill development respects the existing pattern and character of adjacent development. This includes development standards for lot coverage, building depth, floor area ratios, height, number of storeys, garage projections, and garage widths.

Zoning By-Law 2024-19

The subject property is zoned “Residential – Established Neighbourhood Low Rise” (RES-ENLR) under By-law 2024-19, which permits detached dwellings. The proposal does not comply with respect to the side yard setbacks, roof projection and second storey building coverage. Further details on the variances are provided in the comment section below.

Zoning Preliminary Review (ZPR) Not Undertaken

The Owner has confirmed that a Zoning Preliminary Review (ZPR) has not been conducted. However, the applicant has received comments from the building department through their permit process (HP.25.109525) to confirm the variances required for the proposed development. The applicant submitted revised drawings on August 22, 2025. The applicant has not conducted another Housing Review cycle for the revised drawings. Consequently, it is the owner’s responsibility to ensure that the application has accurately identified all the variances to the Zoning By-law required for the proposed development. If the variance request in this application contains errors, or if the need for additional variances is identified during the Building Permit review process, further variance application(s) may be required to address the non-compliance.

COMMENTS

The Planning Act states that four tests must be met in order for a variance to be granted by the Committee of Adjustment:

- a) The variance must be minor in nature;
- b) The variance must be desirable, in the opinion of the Committee of Adjustment, for the appropriate development or use of land, building or structure;
- c) The general intent and purpose of the Zoning By-law must be maintained;
- d) The general intent and purpose of the Official Plan must be maintained.

Reduced Side Yard Setback Variance

The Owner is requesting to permit a minimum west side yard setback of 1.52 m and a minimum combined interior side yard setback on both sides of 3.36 m, whereas the by-law requires a minimum side yard setback of 1.8 m and a minimum combined interior side yard setback on both sides of 4.0 m for the two-storey portion of the dwelling.

The proposed combined side yard setback represents a reduction of 0.64 m from the required setback of 4.0 m, or a 16% decrease. While the requested relief will provide a reduced setback from the west side, Staff opine that the reduced interior sideyards will not adversely impact the character of the neighbourhood.

The proposed interior side yards will continue to maintain adequate space for soft landscaping drainage swales between adjacent properties. Engineering Staff note that the site is in the Thornhill area, which is known as a local flood prone area. The proposed redevelopment will require a Stormwater Management Brief for a complete Residential Infill Grading and Servicing (RGS) application, showing the control of 100-year post-development flows to 2-year or 5-year cycles, dependent on local upgrades. Staff are of the opinion that the requested variance is minor in nature, as the proposed decrease will not have an adverse impact on the neighbouring property.

Roof Projection Variance

The Owner is requesting to permit a roof projection of 2.54 m above the maximum outside wall height, whereas the by-law permits a roof structure with a pitch of less than 25 degrees to project only a maximum of 1.0 m above the maximum outside wall height.

The intent of the maximum roof projection is to maintain a consistent roofline and prevent excessive height that may adversely impact the surrounding properties. It should be noted that the design of the roof, specifically the slope at the front of the roof is consistent with the character of the neighbourhood, and is in line with the by-law's intent to create proper articulation of massing between the first and second storey. Staff are of the opinion that the proposed encroachment is minor in nature, as it maintains an appropriate roofline between neighboring dwellings, and as such, have no concerns.

Increase in Main Building Coverage Variance

The Owner is requesting to permit a main building coverage of 24% for the second storey, whereas the by-law permits a maximum main building coverage of 20%. The intent of the maximum building coverage requirements includes, but are not limited to, ensuring that appropriate angular planes are provided and that the built form and character of the neighbourhood is maintained.

The proposed increase to the main building coverage will increase the dwelling width, which, as explained in the side yard setback variance rationale, is minor in nature.

The proposed dwelling will be providing building lines, front and rear yard setbacks that will be consistent with adjacent properties, maintaining the intent of the By-law to regulate massing along the neighbourhood streetscape. The proposed second-storey and its required relief for building coverage will not significantly add to the scale and massing of the dwelling, and does not alter the character of the neighbourhood. Staff are of the opinion that the requested variance is minor in nature and have no concerns.

PUBLIC INPUT SUMMARY

No written submissions were received as of September 5, 2025. It is noted that additional information may be received after the writing of the report, and the Secretary-Treasurer will provide information on this at the meeting.

CONCLUSION

Planning Staff have reviewed the application with respect to Section 45(1) of The Planning Act, R.S.O. 1990, c. P.13, as amended, and are of the opinion that the variance request meets the four tests of the Planning Act and have no objection. Staff recommend that the Committee consider public input in reaching a decision.

The onus is ultimately on the applicant to demonstrate why they should be granted relief from the requirements of the zoning by-law, and how they satisfy the tests of the Planning Act required for the granting of minor variances.

Please refer to Appendix "A" for conditions to be attached to any approval of this application.

PREPARED BY:



Theo Ako-Manieson, Planner I, West District

REVIEWED BY:



Rick Cefaratti, MCIP, RPP, Acting-Development Manager, West District

File Path: Amanda\File\ 25 125637 \Documents\District Team Comments Memo

APPENDIX “A”

CONDITIONS TO BE ATTACHED TO ANY APPROVAL OF FILE A/084/25

1. The variances apply only to the proposed development as long as it remains;
2. That the variances apply only to the subject development, in substantial conformity with the plan(s) attached as 'Appendix B' to this Staff Report, and that the Secretary Treasurer receive written confirmation from the Supervisor of the Committee of Adjustment or designate that this condition has been fulfilled to their satisfaction;

CONDITIONS PREPARED BY:

A handwritten signature in black ink, appearing to read 'Theo Ako-Manieson', written over a horizontal line.

Theo Ako-Manieson, Planner I, West District

Appendix B

File: 25.123027.000.000000
Date: 9/5/2025
MM/DD/YYYY



ALEKSANDAR V. MARKOVIC

Architecture, Interiors

1 Valley Woods Rd., North York, Ontario M3A 2R4
Cell: (647) 838.0781 Email: a.v.m.design@sympatico.ca

THIS DRAWING MUST BE READ IN THE CONTEXT OF ALL OTHER DRAWINGS WHICH CONSTITUTE THE CONSTRUCTION DOCUMENT. THIS DRAWING WAS DEVELOPED FOR A SPECIFIC PURPOSE. USE FOR ANY OTHER PURPOSE IS NOT PERMITTED. THIS DRAWING SHALL NOT BE REPRODUCED IN WHOLE OR IN PART WITHOUT WRITTEN CONSENT OF THE DESIGNER. ALL DIMENSIONS ARE TO BE VERIFIED ON SITE PRIOR TO FABRICATION, INSTALLATION OR COMMENCING WITH WORK. ANY DISCREPANCIES ARE TO BE REPORTED TO THE DESIGNER FOR CLARIFICATION. DO NOT SCALE THE DRAWINGS.

Issued
ISSUED FOR COMMITTEE OF ADJUSTMENT / SEVERANCE, CONSENT

The undersigned has reviewed & taken responsibility for this design, and has the Qualifications and meets the Requirements set out in the Ontario Building Code to be a designer.

REGISTRATION INFORMATION
Required unless design is exempt under 2.17.4.1. of the Ontario Building Code
Name: LILIANA MARKOVIC 33107 BCDN #
Signature: Aleksandar V. Markovic 34372 BCDN#
Practice Name

Revised		
NO.	REVISIONS	DATE
1	AS PER EXAMINER'S NOTES	MAY, 2025.

Client
Hua Lin
Yuan Chen
Project Name and Address
PROPOSED 2 STOREY DWELLING

76 Highland Park Blvd.,
Markham, ON, L3T 1B5

Drawing Title

EAST
ELEVATION

Checked by

A.M.

Scale

AS NOTED

Drawing/Sheet No

A2.4

Project No:

25-01



1 PROPOSED
EAST ELEVATION
SCALE: 1'-0" = 1/4"
SCALE: 1 : 50

Appendix B

File: 25.12007 000-00000

Date: 9/5/2025
MM/DD/YYYY



ALEKSANDAR V. MARKOVIC
Architecture , Interiors

1 Valley Woods Rd., North York, Ontario M3A 2R4
Cell: (416) 833.0731 Email: a.v.markovic@sympatico.ca

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Signature Aleksandar V. Markovic 34372 BCDN #
Practice Name

Revised

NO.	REVISIONS	DATE
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Client

Hua Lin
Yuan Chen

Project Name and Address
PROPOSED 2 STOREY DWELLING

76 Highland Park Blvd.,
Markham, ON, L3T 1B5

Drawing Title

NORTH
ELEVATION

Checked by

A.M.

Scale

AS NOTED

Drawing/Sheet No

A2.3

Project No:

25-01


1

PROPOSED

NORTH ELEVATION

SCALE: 1'-0" = $\frac{1}{4}$ "

SCALE: 1 : 50

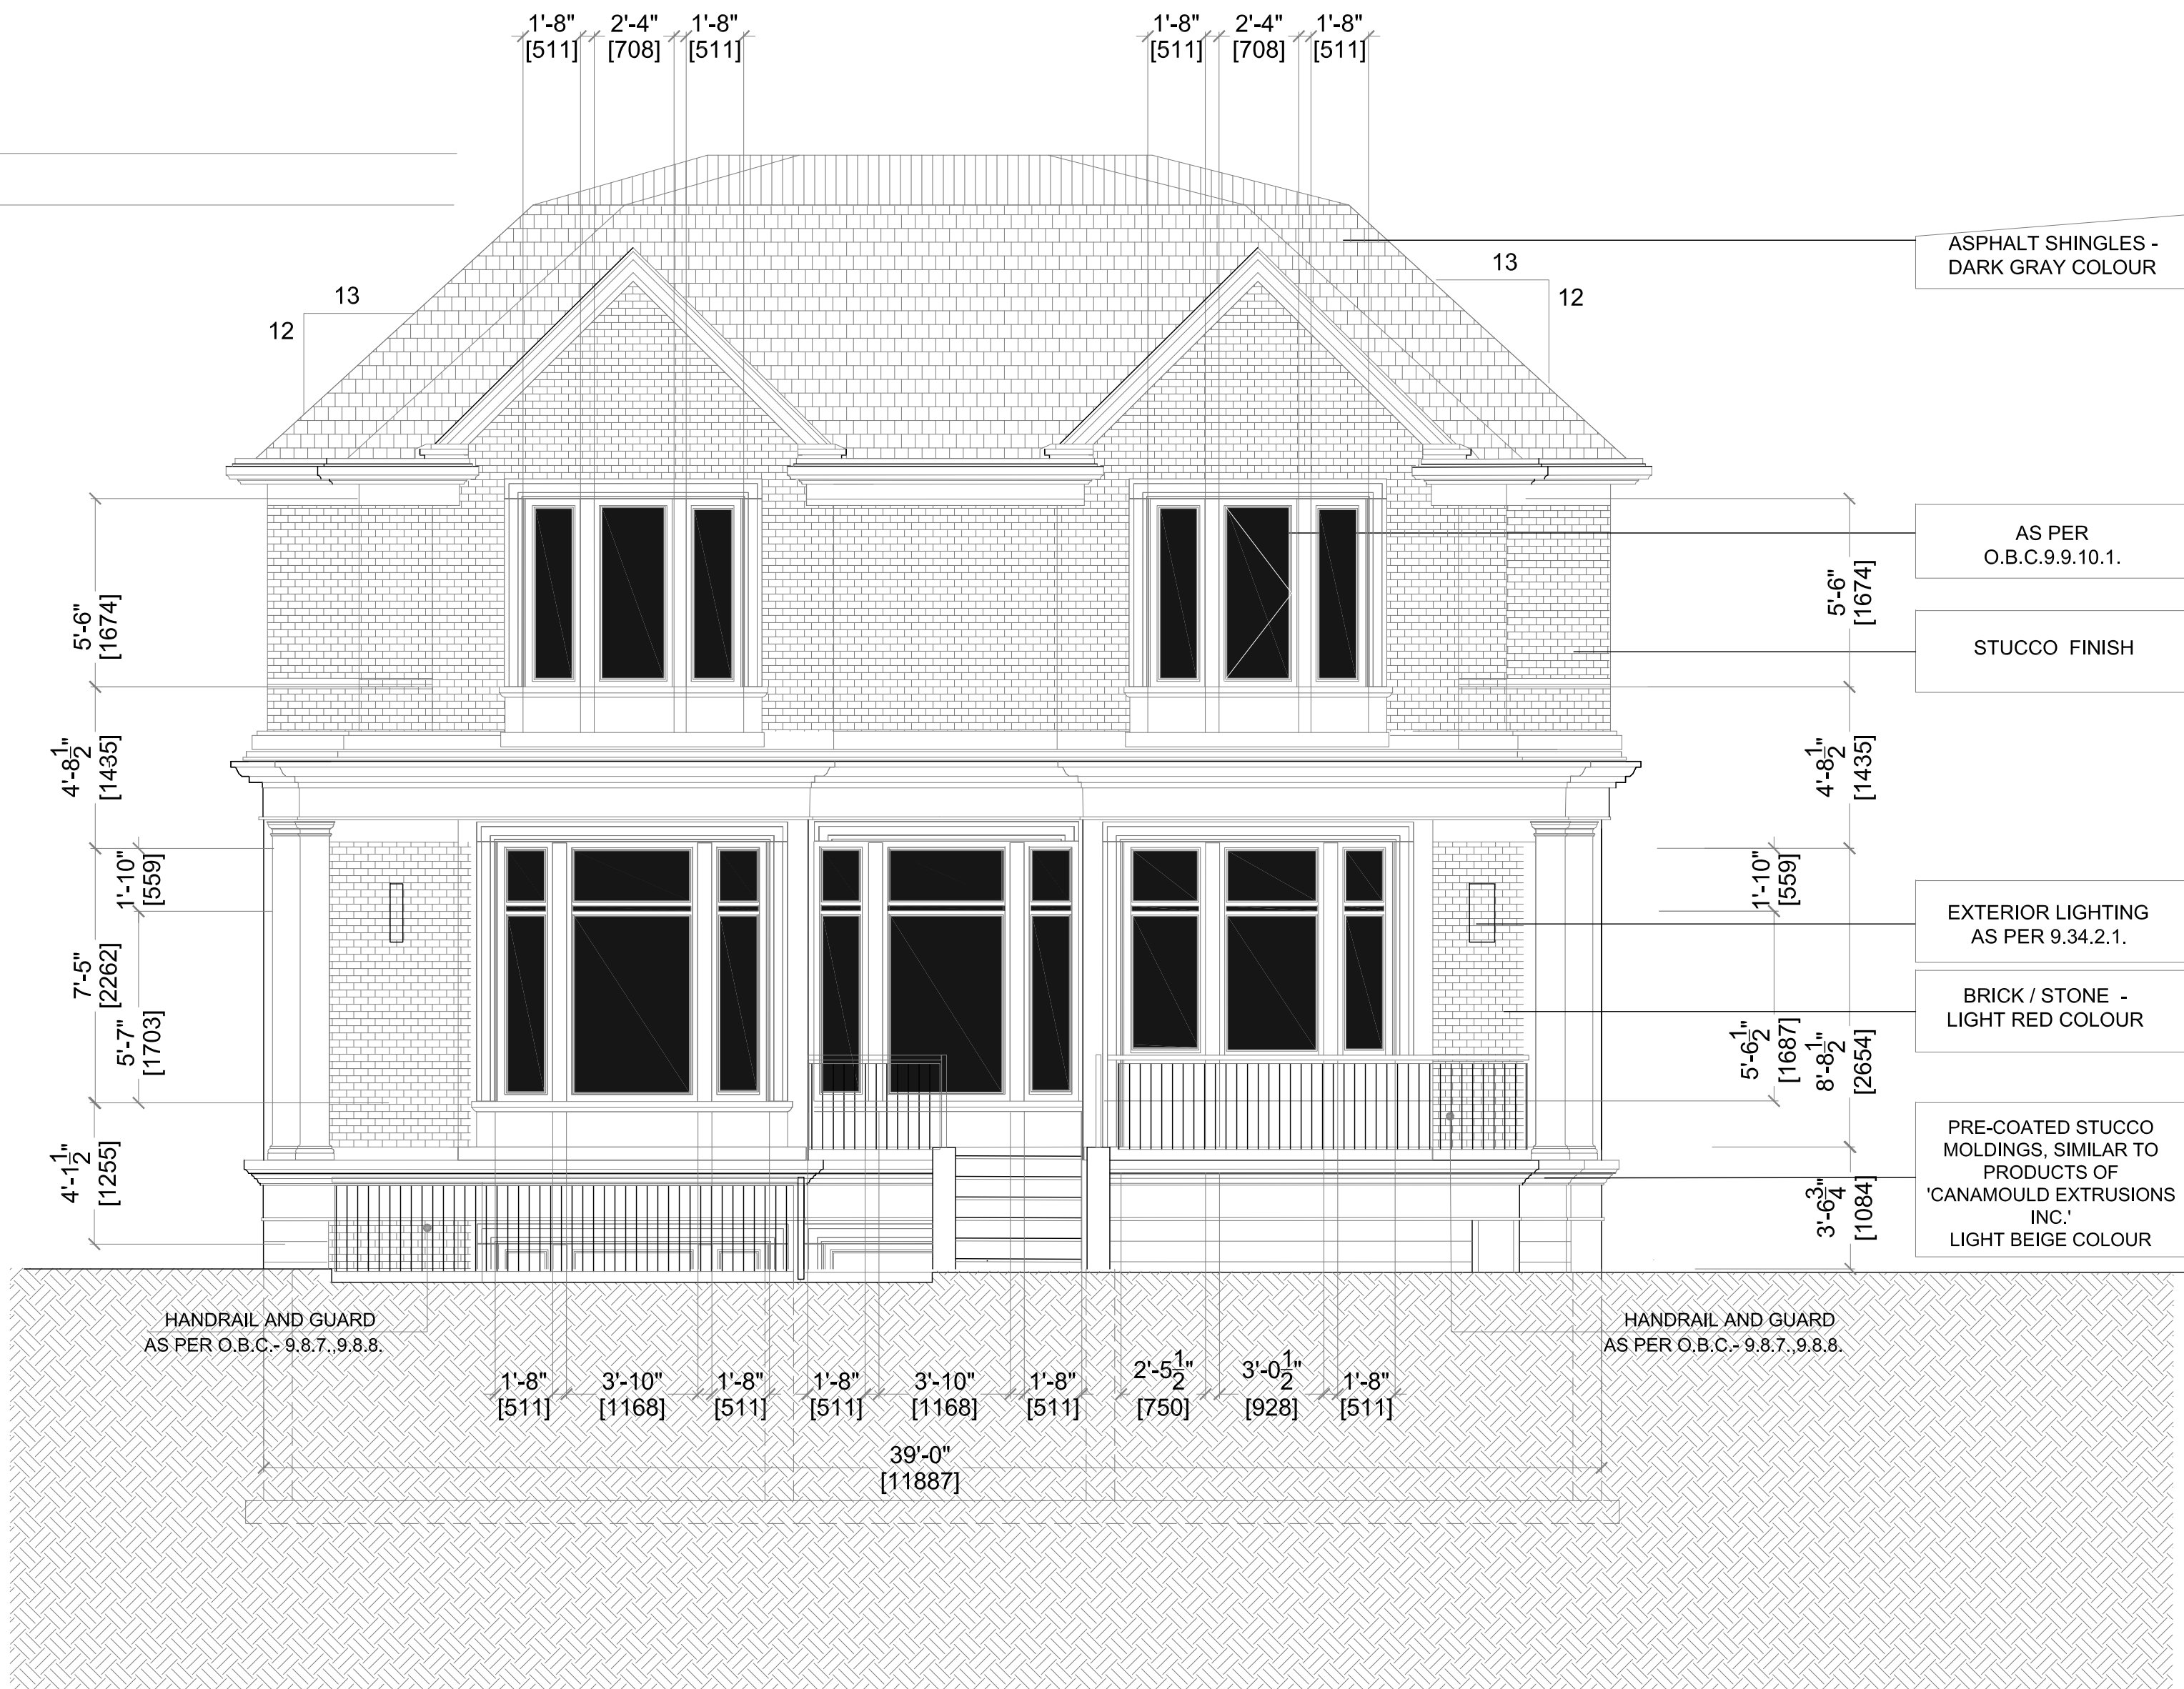

Appendix B

File: 25.12007.000.00000
Date: 9/5/2025
MM/DD/YYYY



ALEKSANDAR V. MARKOVIC
Architecture . Interior

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Name: ALEKSANDAR V. MARKOVIC 33107 BCDN #
Signature: Aleksandar V. Markovic 34372 BCDN #
Practice Name

Revised _____
NO. REVISIONS DATE
1 AS PER EXAMINER'S NOTES MAY, 2025.

Client _____

Hua Lin
Yuan Chen

Project Name and Address _____
PROPOSED 2 STOREY DWELLING

76 Highland Park Blvd.,
Markham, ON, L3T 1B5

Drawing Title _____

SOUTH
ELEVATION

Checked by _____

A.M.

Scale _____

AS NOTED

Drawing/Sheet No. _____

A2.1

Project No. _____

25-01



1 **PROPOSED
SOUTH ELEVATION**

SCALE: 1'-0" = $\frac{1}{4}$ "

SCALE: 1 : 50

Appendix B

File: 25.12007.000.000000
Date: 9/5/2025
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AM
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Signature: Aleksandar V. Markovic 34372 BCDN#
Practice Name

NO.	REVISIONS	DATE
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2		
3		

Client

Hua Lin
Yuan Chen
Project Name and Address
PROPOSED 2 STOREY DWELLING

76 Highland Park Blvd.,
Markham, ON, L3T 1B5

Drawing Title

WEST
ELEVATION

Checked by

A.M.

Scale


AS NOTED

Drawing/Sheet No

A2.2

Project No:

25-01

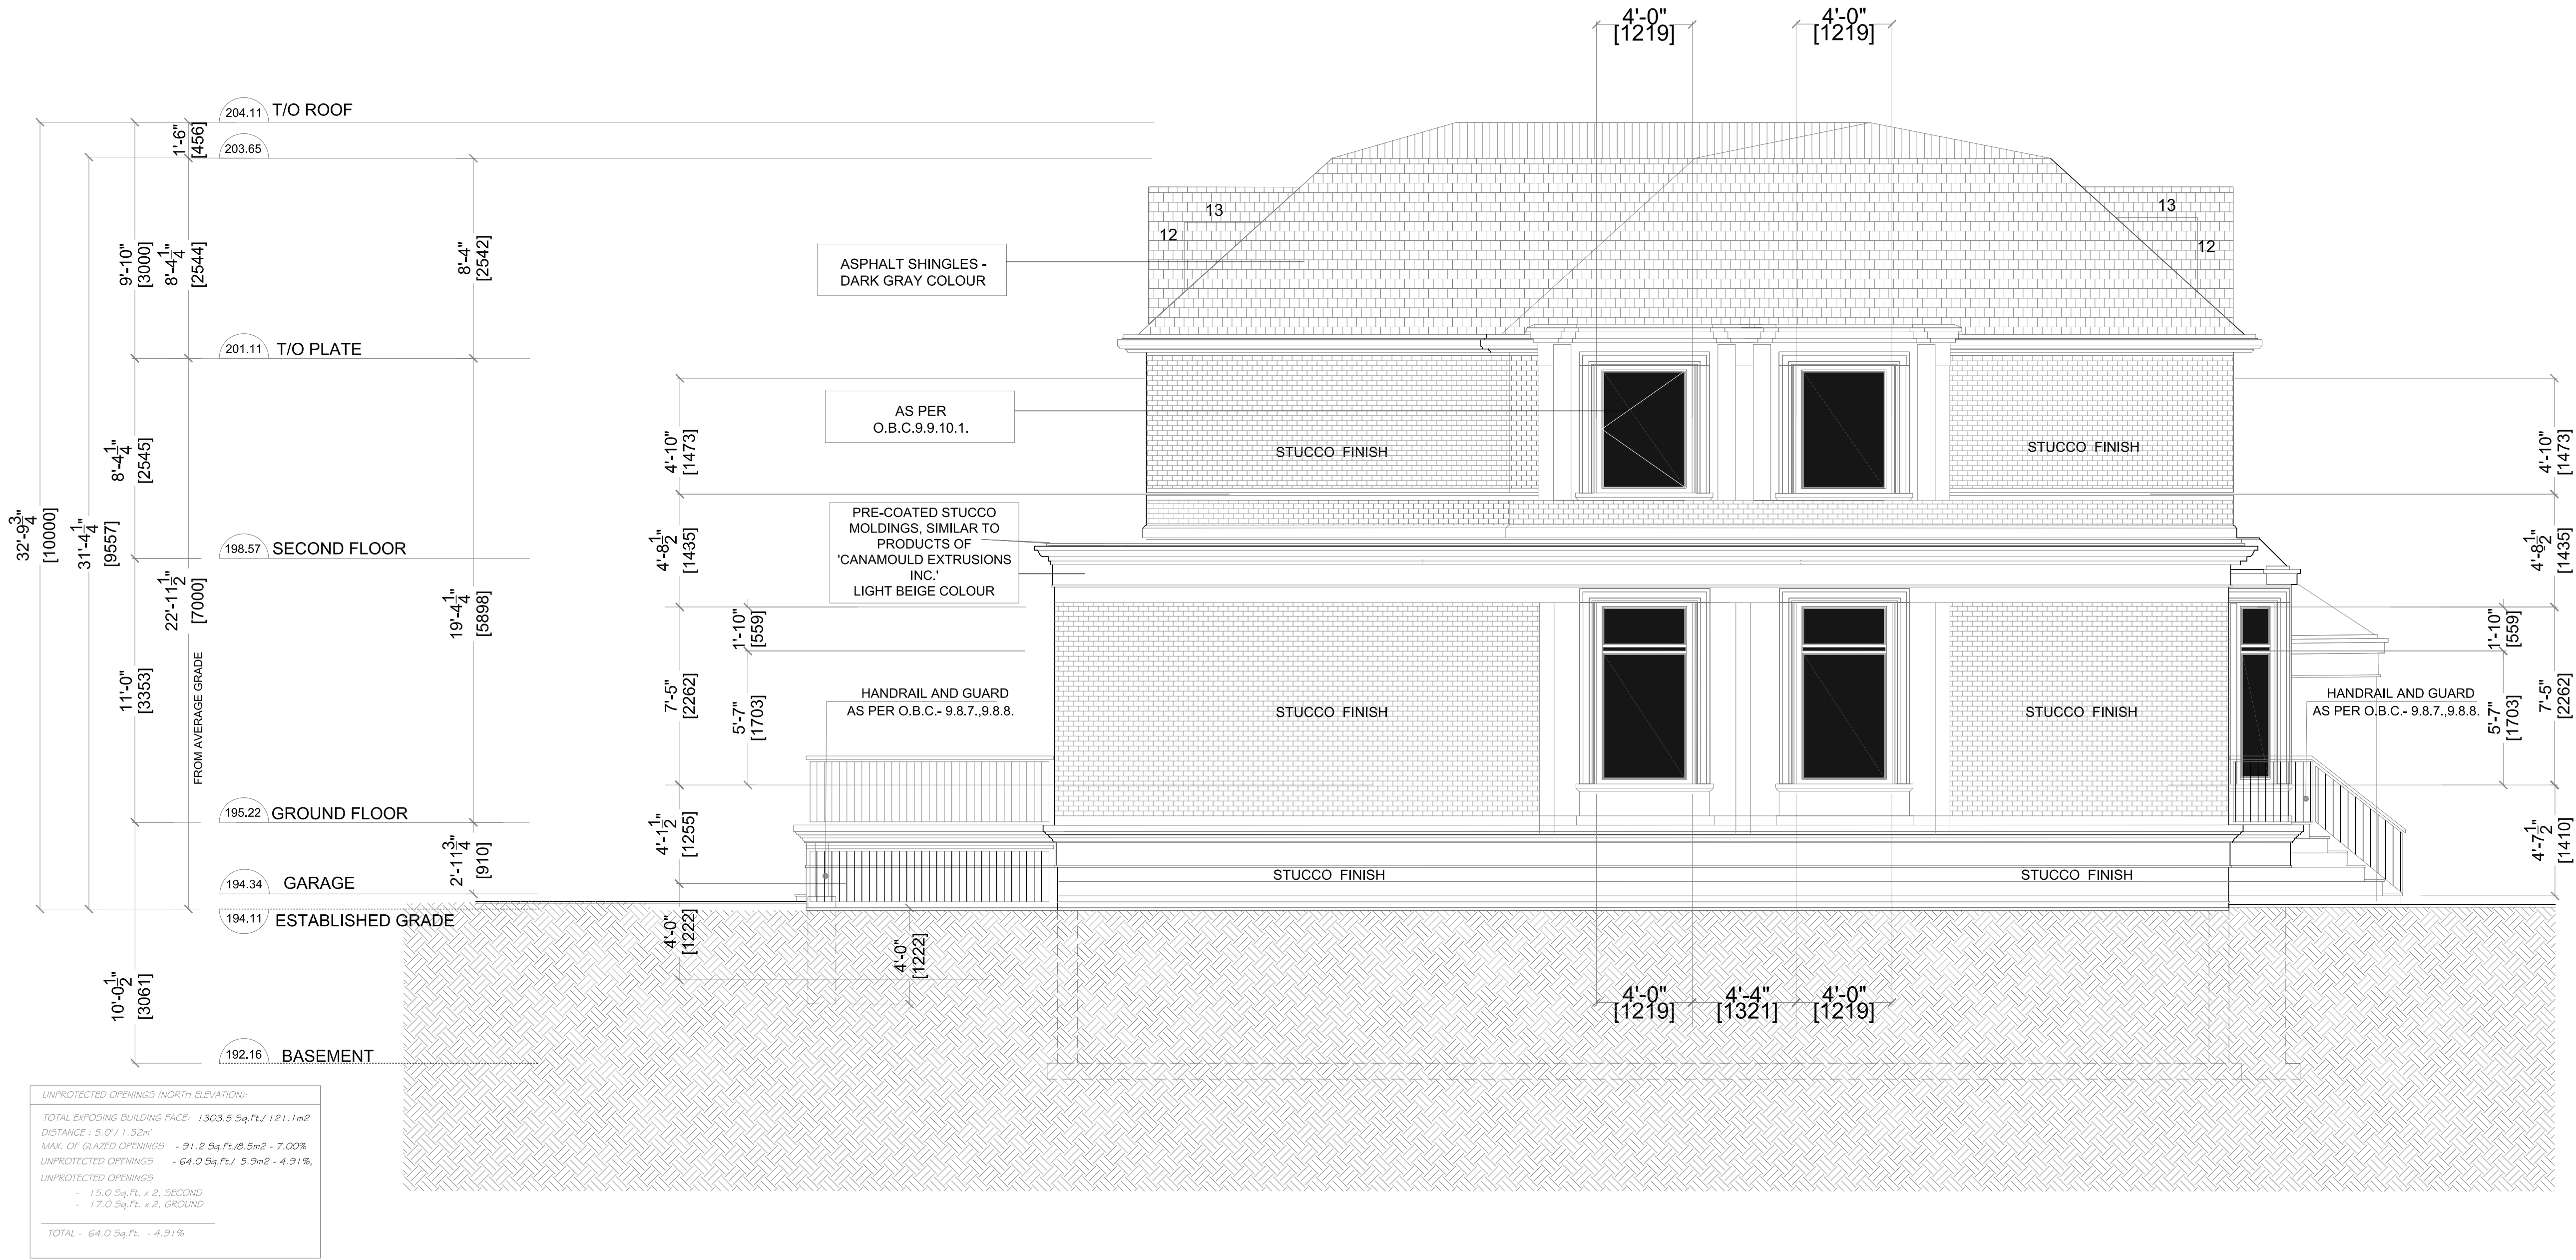


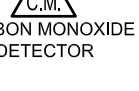
1 **PROPOSED**
WEST ELEVATION
SCALE: 1'-0" = $\frac{1}{4}$ "
SCALE: 1 : 50

4

PROPOSED ROOF PLAN

SCALE: 1'-0" = $\frac{1}{4}$ "
SCALE: 1 : 50

LEGEND

 SMOKE ALARM	REQUIRED SMOKE ALARMS WITHIN EACH DWELLING UNIT	MAY BE BATTERY OPERATED EXCEPT WHERE SMOKE ALARMS ARE REQUIRED TO BE INTERCONNECTED DUE TO SEPARATION BETWEEN UNITS AND EGRESS REQUIREMENTS. ALARMS MUST BE LOCATED ON OR NEAR THE CEILING WITHIN 30' OF BEDROOM DOORS.
 CARBON MONOXIDE DETECTOR	REQUIRED CARBON MONOXIDE DETECTORS WITHIN EACH DWELLING UNIT ADJACENT TO EACH SLEEPING AREA	MUST CONFORM TO CAN/CSA 4.19 OR UL 2034 CO DETECTORS MAY BE BATTERY OPERATED OR PLUGGED INTO AN ELECTRICAL OUTLET.

IMPORTANT NOTICE

ALL STRUCTURAL ELEMENTS RECOMMENDED BY STRUCTURAL ENG. WILL BE VERIFIED BY FLOOR JOISTS / ROOF TRUSSES MANUFACTURER

IMPORTANT NOTICE

ALL THERMAL INSULATION INFORMATION CAN BE FIND IN ENERGY EFFICIENCY DESIGN SUMMARY

Energy Efficiency Design Summary: Prescriptive Method (Building Code Part 9, Residential)

This form is used by a designer to demonstrate that the energy efficiency design of a house complies with the building code using the prescriptive method described in Subsection 3.1.1.1 of SB-12. This form is applicable where the ratio of gross area of windows/sidelights/skylights/glazing in doors and sliding glass doors to the gross area of peripheral walls is not more than 22%.

Application No:		Model/Certification Number:	
For use by Principal Authority			
A. Project Information			
Building name, street name:		Unit number:	Location:
76 Highland Park Blvd			
Municipality:		Postal code:	Tag, year number, other description:
Markham			
B. Prescriptive Compliance (indicate the building code compliance package being employed in this house design)			
SB-12 Prescriptive (input design package): Package: A1 Table: 3.1.1.2.A(IP)			
C. Project Design Conditions			
Climatic Zone (SB-12):	Heating Equipment Efficiency	Space Heating Fuel Source	
Zone 1 (< 5000 degree days)	≥ 92% AFUE	Gas	
Zone 2 (≥ 5000 degree days)	≥ 84% < 92% AFUE	Oil	
		Electric	
		Solid Fuel	
		Earth Energy	
Ratio of Windows, Skylights & Glass (W, S & G) to Wall Area			
Area of walls = 398.7 m ² or ft ²		W, S & G = 18.1	
Area of W, S & G = 72.3 m ² or ft ²		Log Post&Beam	
		ICF Above Grade	
		Slab-on-ground	
		Walkout Basement	
		Air Conditioning	
		Combo Unit	
		Air Sourced Heat Pump (ASHP)	
		Ground Sourced Heat Pump (GSHP)	


D. Building Specifications (provide values and ratings of the energy efficiency components proposed)

Energy Efficiency Substitutions

- ☐ ICF (3.1.1.2.(5) & (6) / 3.1.1.3.(5) & (6))
☐ Combined space heating and domestic water heating systems (3.1.1.2.(7) / 3.1.1.3.(7))
☐ Airtightness substitution(s)

Building Component	Minimum RSI / R values or Maximum U-Value ⁽¹⁾		Building Component	Efficiency Ratings
	Nominal	Effective		
Thermal Insulation			Windows & Doors	Provide U-Value ⁽¹⁾ or EER rating
Ceiling with Attic Space	60	59.22	Windows/Sliding Glass Doors	0.25
Ceiling without Attic Space	31	27.05	Skylights/Claazed Roofs	0.49
Exposed Floor	31	29.8	Mechanicals	
Walls Above Grade	22	17.03	Heating Equip.(AFUE)	
Basement Walls	20 ci	21.12	HRV Efficiency (BRE% at 0° C)	96%
Slab (at ≥600mm below grade)	10		DHW Heater (EF)	0.8
Slab (edge only ≤600mm below grade)	10		DWHR (CSA B55.1 (min. 42% efficiency))	42% # Showers
Slab (at ≤600mm below grade, or treated)	10	11.13	Combined Heating System	

(1) U value to be provided in either W/(m²·K) or Btu/(h²·F) but not both.

E. Designer(s) (name(s) & BCIN(s), if applicable, of person(s) providing information herein to substantiate that design meets the building code)		
Qualified Designer: Declaration of designer to have reviewed and take responsibility for the design work.		
Name: Dan Pusica	BCIN: 21266	Signature: 



Appendix B

File: 

Date: 9/5/2025
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Aleksandar V. Markovic	34372
Practice Name	BCDN#

Revised _____

NO.	REVISIONS	DATE
1	AS PER EXAMINER'S NOTES	MAY, 2025.
2		

Client _____

Hua Lin
Yuan Chen

Project Name and Address
PROPOSED 2 STOREY DWELLING

76 Highland Park Blvd.,
Markham, ON, L3T 1B5

Drawing Title _____

ROOF PLAN

Checked by _____

A.M.

Scale _____

AS NOTED

Drawing Sheet No. _____

A1.5

Project No. _____

25-01