

CITY: MARKHAM, ON

MUNICIPAL ADDRESS

13 EBERLY WOODS DR, MARKHAM

SCOPE OF WORK

- PERMIT DRAWING FOR TWO STEPS SIDE DOOR STAIRCASE

LEGEND

EXISTING WALL PROPOSED WALL CONCRETE WALL WALLS TO BE **REMOVED** BEAM **FLOOR JOIST POST** \boxtimes **HSS POST ROUND POST** \otimes PROPERTY LINE

REVISION CLOUD REVISION NUMBER ◬

—п–

 \bigoplus

MIN 45 MIN FIRE SEPARATION

FENCE

SUPPLY AIR REGISTER

 \bowtie RETURN AIR GRILLE

EXHAUST FAN

FLOOR DRAIN

SMOKE DETECTOR AND SMOKE ALARM

CARBON MONOXIDE DETECTOR/ALARM

SPRINKLER

ADD ADDITIONAL ARCH ARCHITECTURAL BELOW

ABOVE

ABBREVIATIONS

CENTERLINE CLOSET COL C/W CONC COLUMN COMPLETE WITH

CONT DP CONTINUOUS DEPTH DET DETAIL DIA DJ DOUBLE JOIST DWL DOWEL EACH FACE

ELEC FI FCTRICAL ELECTRICAL PANEL **ELEVATION** EQ EX EXPJ EQUAL EXISTING EXPANSION JOINT **FURNACE** FIN FINISHED

EACH WAY

FIREPLACE FLOOR DRAIN FD FOUNDATION WALL GALV GALVANIZED HEIGHT HORIZONTAL HOR

INNER FACE INT INTERIOR LOAD BEARING LOWER LAYER MAXIMUM

MECH

O.F

PC PROJ

PRO

SD

STIF STRU

THK T&B

TOC

TOS TOW

TYP U/S

UNO

VER

WIC

WWF

UL

NLB NTS NON-LOAD BEARING NOT TO SCALE ON CENTER OPEN

OUTER FACE **PRECAST**

PROJECTION

PROPOSED

MECHANICAL

REINFORCED WITH SHORT DIRECTION STIFFENER STRUCTURAL THICKNESS

TOP AND BOTTOM TOP OF CONCRETE TOP OF FLOOR TOP OF STEEL TOP OF WALL

TRIPLE JOIST TYPICAL UNDERSIDE UNLESS NOTED OTHERWISE

VERTICAL WALKING CLOSET WALL PLATE WATER HEATER

WELDED WIRE FABRIC WIDTH WITH

DRAWING LIST

A-00 COVER SHEET

A-01 SITE PLAN

A-02 EX. BASEMENT PLAN

A-03 PRO. BASEMENT PLAN

A-04 EX. GROUND FLOOR PLAN A-05 PRO. GROUND FLOOR

PLAN

A-06 EX. SECOND FLOOR PAN

STANDARDS, LOADS & ASSUMPTIONS:

THE ENGINEERING HAS PERFORMED BASED ON THE LATEST UPDATE OF THE 2024 ONTARIO BUILDING CODE COMPENDIUM, WHICH IS A REGULATION MADE UNDER THE BUILDING CODE ACT, 1992, AND ALSO THE REFERRED STANDARDS.

STRUCTURAL DESIGN BASIS:

NO STRUCTURAL ALTERATION CONSIDERED IN DESIGN. ALL EXISTING STRUCTURAL COMPONENTS TO REMAIN.

PERMIT MAN **BUILDING DESIGN SERVICES**

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DRAWINGS ARE SEALED FOR THE PROPOSED ALTERATIONS ONLY. ANY OTHER WORK IS BEYOND THE SCOPE OF WORK

DISCLAIMER:

- No warranty, express or implied, is made regarding the accuracy of dimensions or levels
- All dimensions and levels must be verified on-site before work begins, and any discrepancies must be reported for review. These drawings are not for quantity estimates and compositions of walls and floors, as well as other concealed or
- unobservable components, have not been determined, and no liability is assumed
- Shoring, site grading, and flood control are beyond the engineer's scope, and no liability
- Soil bearing capacity and groundwater levels must be assessed by a geotechnical engineer before construction. Consult the local building department for soil-bearing capacity information.

				JOB NO & DATE:
				25222 MAR 2025
				DRAWN BY: M.M
2	2025/04/24	ISSUED FOR PERMIT	CITY	CHECKED BY:
1	2025/04/03	ISSUED FOR PERMIT	CITY	F.F.R
0	2025/03/31	ISSUED FOR REVIEW	CLIENT	PAPER SIZE:
REV	DATE	DESCRIPTION	NOTE	17"x11"

PERMIT DRAWING FOR TWO STEPS SIDE DOOR STAIRCASE


ADDRESS:

13 EBERLY WOODS DR, MARKHAM

DRAWING

COVER SHEET

REV NO: REV 2 PAGE NO: A-00

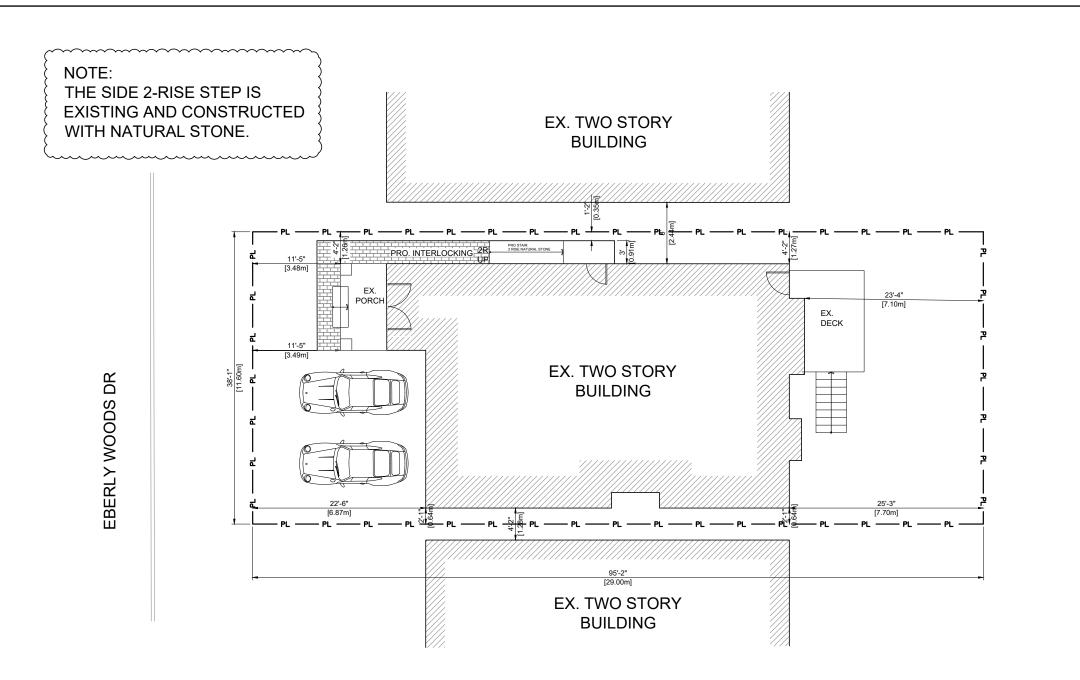



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SCOPE OF PERMIT DRAWING FOR TWO STEPS CIDE DOOR STEPS SIDE DOOR STAIRCASE

ADDRESS:

13 EBERLY WOODS DR, MARKHAM

DRAWING TITLE:

SITE PLAN

REV NO: REV 2

PAGE NO: A-01

SITE PLAN

SCALE 1:150

SITE STATICS						
LOT AREA: 336.40 M^2 / SIDE YARD AREA: 29.84 M^2						
SITE STATISTICS	PERMITTED	EXISTING	PROPOSAL			
LOT FRONTAGE	MIN. 10.7 M	11.60 M	-			
SIDE SETBACK	1.2 M	1.26 M	-			
SIDE SETBACK ENCROACHMENT	NOT CLOSER THAN 0.6 METERS FROM THE RESPECTIVE LOT LINE	1.26 M	0.35 M			